

ADVISORY DESIGN PANEL

WEDNESDAY, SEPTEMBER 10, 2025 AT 7:00 PM

Council Chambers Langley City Hall (In-Person Meeting)

AGENDA

1) AGENDA

Adoption of the September 10, 2025 agenda.

2) MINUTES

Adoption of minutes from the July 30, 2025 meeting.

3) DEVELOPMENT PERMIT APPLICATION DP 03-25

5470 203 Street

4) **NEXT MEETING**

Date to be confirmed.

5) ADJOURNMENT



MINUTES OF THE ADVISORY DESIGN PANEL

HELD IN COUNCIL CHAMBERS, LANGLEY CITY HALL

WEDNESDAY, JULY 30, 2025 AT 7:00 PM

Presenta: Councillor Paul Albrecht (Chair)

Councillor Mike Solyom (Co-Chair)

Himanshu Chopra Melissa Coderre Jaswinder Gabri Matt Hassett Leslie Koole Tana McNicol

Samantha Stroman

Ritti Suvilai

Absent: Tracey Macatangay

Staff: C. Johannsen, Director of Development Services

K. Kenney, Corporate OfficerJ. Lee, Planning AssistantA. Metalnikov, Senior Planner

Chair Albrecht began by acknowledging that the land on which we gather is on the traditional unceded territory of the Katzie, Kwantlen, Matsqui and Semiahmoo First Nations.

1) AGENDA

Adoption of the July 30, 2025 agenda

It was MOVED and SECONDED

THAT the July 30, 2025 agenda be adopted as circulated.

CARRIED

2) MINUTES

Document Number: 203800

201679

Adoption of minutes from the April 16, 2025 meeting

It was MOVED and SECONDED

THAT the minutes of the April 16, 2025 Advisory Design Panel meeting be approved as circulated.

CARRIED

3) <u>DEVELOPMENT PERMIT APPLICATION DP 10-24</u> 20622 Langley Bypass

Mr. Metalnikov introduced the application and spoke to the staff report dated July 11, 2025.

The Applicant team was in attendance as follows:
Dave Doerksen, Director Real Estate Operations, Go Auto Group (via videoconference, entering meeting 7:23 pm)
Al Tanzer, Landscape Architect, LandSpace Design Inc.
Jana Wissmann, Representative, Christopher Bozyk Architects Ltd

The applicant team provided a PowerPoint presentation with information on the following:

- The design is intended to enhance customer experience and sustainability;
- Details on current and proposed landscaping elements in the following areas:
 - Street frontage;
 - Bioswale:
 - Drive way;
 - Area in front of showroom;
 - Walkway from frontage road;
- Building design:
 - Building improvement façade;
 - Signage;
 - South and north elevation:
 - East elevation:
 - West elevation;
 - Main floor plan;
 - Second level floor plan mezzanine;
 - Building envelope;
- Sustainability features;
- Amenities.

The applicant team responded to questions and received feedback from Panel members regarding the form and character of the building as follows:

- Rationale for having second entry to the lot;
- Using reflective roof material to reduce heat island effect;
- Potential to have landscaping in riparian and bioswale areas;
- Providing display at entryway, (ex. vehicle on boulder), to provide more visual impact;
- Using more plantings on property boulevard to beautify neighbourhood;
- Having plantings at rear of property if possible;
- Ensure plantings near parking islands do not negatively impact vehicles and drivers;
- Security features in place for walkway between property and neighbouring building;
- Potential for frontage road to be used as an accessway in the future;
- Technology used to achieve better energy efficiency;
- Consider having separate outside covered seating areas for staff/customers;
- Have as many trees as possible to add cooling, including in planters;
- Provision of amenities inside for children.

It was MOVED and SECONDED THAT:

The ADP receive the staff report dated July 11, 2025 for information; and

The ADP recommends the applicant give further consideration to the following prior to the application proceeding to Council:

- a. Consider increasing plantings within the bioswale on the south end of the site;
- b. Explore a more prominent entryway feature (e.g. boulder/rock features, vehicle display, larger plantings/trees, etc.) integrated with the landscaping
- c. Review plantings within parking lot landscape beds for conflict with vehicles (e.g. door swing);
- d. Consider an outdoor seating area for staff;
- e. Consider an outdoor seating area for customers and a child-oriented amenity area within the building;
- f. Provide a high-albedo roof treatment to increase solar reflectivity and reduce the urban height island effect;
- g. Consider opportunities for additional tree plantings.

CARRIED

4) **NEXT MEETING**

September – date to be confirmed.

5) ADJOURNMENT

It was MOVED and SECONDED

THAT the meeting adjourn at 8:00 pm.

<u>CARRIED</u>

ADVISORY DESIGN PANEL CHAIR

CORPORATE OFFICER



ADVISORY DESIGN PANEL REPORT

To: Advisory Design Panel

Subject: **Development Permit Application DP 03-25**

(5470 203 Street - Langley Lions Alder Building)

From: Ji Woo Lee, BSc., MCRP Bylaw #:

Planning Assistant II

File #: 6620.00

Date: August 29, 2025 Doc #:

RECOMMENDATION:

THAT this report be received for information.

1. PROPOSAL:

Development Permit application for an 8-storey, 188-unit apartment building at the Langley Lions Seniors District in replacement of the previous "Alder" building in the same location at 5470 203 Street.

2. CITY BYLAWS & POLICIES:

Applying to the subject properties:

- a. **Official Community Plan (OCP):** Transit-Oriented Residential (maximum 15-storey height and Floor Area Ratio of 4.5);
- b. **OCP Appendix B: District Policies:** Langley Lions Seniors District (maximum 15-storey height and Floor Area Ratio of 2.5);
- c. **Zoning:** CD70 Comprehensive Development Zone; and
- d. **Transit Oriented Area:** Tier 3 (minimum allowable 8-storey height and Floor Area Ratio of 3, no residential parking requirements).

The proposed development:

- a. Is consistent with the OCP (including its Appendix B: District Policies);
- b. Is consistent with the property's existing zoning; and
- c. Requires a Development Permit for a multi-unit residential development.
- d. Requires a housing agreement (per OCP Appendix B: District Policies)



Subject: Development Permit Application DP 03-25

Page 2

3. DETAILED BACKGROUND INFORMATION

Applicant: DYS Architecture

Owner: Langley Lions Housing Society

Civic Address: 5470 203 Street

Legal Description: Lot 4 and an Undivided 18/100th Share in Lot 1,

District Lot 36, Group 2, New Westminster District, Plan EPP107406, See Plan as to Limited Access

Site Area: Subject property: 3,212 m² (0.79 ac)

Full District: 2.89 ha (7.14 ac)

Number of Units: 188 apartments

Gross Floor Area: 13,543.6 m² (145,782.3 ft²)

Floor Area Ratio (Full Proposal only: 0.469

District lot area): Proposal with existing buildings: 1.744

Lot Coverage (Full Proposal only: 5.9%

District lot area): Proposal with existing buildings: 38.1%

Parking Required: 9 accessible spaces

Parking Provided: 46 spaces (including 9 accessible spaces)

OCP Designation: Transit-Oriented Residential & Langley Lions Seniors

District

Zoning: CD70 Comprehensive Development Zone

Variances Requested: Indoor amenity of 241.9 m² (432.4 m² required) **Estimated** \$4.556.520.00 (City - \$2.549.520.00, GVS&DD -

Estimated \$4,556,520.00 (City - \$2,549,520.00, GVS&DD - **Development Cost** \$876,240.00, GVWD - \$814,920.00, MV Parks - **Charges (DCCs):** \$36,360.00, SD35 - \$72,000.00, TransLink -

\$207.480.00)

Community Amenity Not applicable (to be confirmed based on final rental

Contributions (CACs): program)

4. SITE CONTEXT (5470 203 Street)


The proposed development site consists of a single vacant property within the larger Langley Lions Seniors District site. Its surroundings include:

- North: Langley Mall (active rezoning application for a high-density mixeduse multi-phase redevelopment);
- **East:** Existing 4-storey Langley Lions "Evergreen Timbers" building and under-construction 8-storey "Birch" Building);
- South: Existing Langley Lions "Cedar" building; and
- **West:** 203 Street (arterial) with existing 4-storey apartment building and Transit-Oriented Residential-designated single-detached homes across.



Subject: Development Permit Application DP 03-25

Page 3

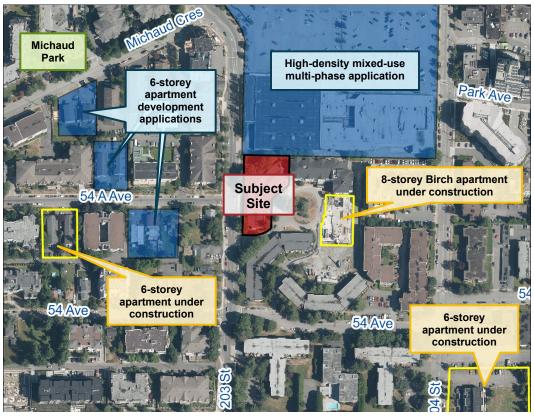

Context Map

The site is adjacent to Downtown and benefits from access to its shops and services. Other key neighbourhood amenities within a 5-minute walk include Linwood Park, Michaud Park, and Timms Community Centre.

Nearby transportation services include:

- 564 Langley Centre/Willowbrook bus route (directly adjacent);
- Langley Centre exchange and its 14 bus routes, including the frequent 503 Fraser Highway Express (10-minute walk); and
- The under-construction Langley City Centre SkyTrain station and its associated transit exchange (5-to-10-minute walk).

5. PROPOSED SITE AND BUILDING DESIGN

A. Site Layout and Building Massing

The site is zoned CD70 and forms the Langley Lions Master Plan, which received rezoning approval in 2021 (RZ 04-19). The proposed development represents Phase 1B of this multi-phased project. The site plan is consistent with the approved master plan and is submitted for review of the proposed building's form and character. The proposed development is for a flat-roofed



Subject: Development Permit Application DP 03-25

Page 4

steel construction building. The building has an L-shaped footprint oriented to frame the existing courtyard and vehicle access lane to the south that is shared with the Birch building, which is nearing completion, and other buildings that will come in subsequent development phases.

The longer building wing is oriented north-south fronting 203 street and the shorter wing is oriented west-east along the north property line, with the main building entrance also on 203 Street. Service access is accommodated through a loading bay off the auto court.

B. Building Elevations and Materials

The proposed building is expressed as a rectilinear form. Primary façade materials consist of fibre-cement panels in shades of white and grey. Balconies are incorporated along the façades, with continuous balcony and roof deck lines extending to the top of the sixth floor to create a stepped back effect at the top two storeys.

To reduce the perceived width and height, the design incorporates copperorange accent panels at stairwell corners and by the building entrance to enhance verticality, horizontal striping at selected locations, and coloured balcony door frames placed at intervals along the façades.

C. Landscaping

The ground floor features an outdoor deck area connected directly to the indoor amenity space. A rooftop amenity deck features sitting booths beneath aluminum arbors separated with plant walls, movable lounge furniture, and raised urban agriculture beds. A lawn bowling area is provided in an outdoor space to the north of the building and extended paved walkways and plantings are planned along the parameter.

The landscape plan includes a variety of ornamental and native plantings, such as dwarf red osier dogwood, bigleaf hydrangea, Hill's yew, and sweet box. A total of 13 new trees are proposed, including Pacific Fire vine maple, October Glory red maple, river birch, and Daybreak magnolia, which will contribute to seasonal interest and canopy coverage on site.

D. Building Program and Details

The building's unit mix includes:

- 173 one-bedroom units (92%); and
- 15 two-bedroom units (8%)



Subject: Development Permit Application DP 03-25

Page 5

This unit mix composition reflects the intent of the Langley Lions Seniors District to operate buildings not-for-profit primarily for low-income seniors.

Additionally, the owner currently has an active application for BC Housing's Community Housing Fund (CHF) program which, for successful applicants, requires 70% of units to be rented at non-market rates geared to income of tenants (20% of units for tenants below Deep Subsidy Income Limits and 50% of units for tenants below Housing Income Limits or "HILS"), with the remaining 30% of units rented at low/moderate market rents. The final rent level distribution is subject to change based on the funding source the owner is able to secure for this development. A housing agreement is required according to OCP Appendix B: 07. Langley Lions Seniors District Policy.

As a seniors-oriented building, all 188 units are either adaptable (180 units) or accessible (8 units). 696 m² (7,492 ft²) of total amenity space is provided, including 241.9 m² (2,604 ft²) of indoor space and 453.7 m² (4,884 ft²) of outdoor space split between two grade-level areas and a rooftop deck.

6. SUSTAINABILITY FEATURES

- Construction techniques that minimize site disturbance and protect air quality;
- Lighting systems meeting ground-level and dark skies light pollution reduction principles;
- Incorporating a construction recycling plan and the use of recycled building materials;
- Energy performance of 25% better than the current Model National Energy Code for multi-unit residential buildings;
- Heat recovery ventilation;
- Reduced heat island effect with a landscaped rooftop deck;
- Non-water dependent and drought-tolerant materials in the landscape design served by an irrigation system with central control and rain sensors;
- Water-conserving toilets;
- All parking stalls pre-wired for electric vehicle charger installation, with one charger installed; and
- Dedicated scooter parking.

7. CPTED

The applicant's proposal benefited from a comprehensive Crime Prevention Through Environmental Design (CPTED) review by a qualified consultant whose recommendations were incorporated into the plans.



Subject: Development Permit Application DP 03-25

Page 6

8. VARIANCES

A variance has been requested for the size of the indoor amenity area in recognition of the amount of outdoor amenity provided. The current Zoning Bylaw requires indoor amenity space to be provided at a rate of 2.3 m² per unit. while outdoor amenity is required in the OCP without a specific size requirement. Staff support this variance due to the large combined indoor and outdoor amenity provided and the proposal's consistency with the updated requirements proposed for the new Zoning Bylaw. These draft requirements, which were presented at and received support in both rounds of Zoning Bylaw public engagement, are proposed to quantify outdoor amenity requirements and increase the total required amenity supply while providing flexibility in how this overall supply is shared between indoor and outdoor areas and recognizing the economies of scale in larger buildings. In the context of this development, the amenity space being weighted toward outdoor space allows more indoor space to be dedicated to non-market seniors housing, and the overall Langley Lions Seniors District urban design concept is based on large, buildingbounded courtyard areas that provide outdoor amenities for District residents.

A comparison of current and draft new Zoning Bylaw amenity requirements, and the development's proposed amenity, is summarized in the following table:

	Current Zoning Bylaw min. requirement	Draft new Zoning Bylaw min. requirement	Proposed development
Indoor	432.4 m ²	159 m ²	241.9 m ²
Outdoor	N/A	159 m ²	453.7 m ²
Combined	432.4 m ²	476 m ²	695.6 m ²
Total			

Based on the above rationale, staff support this variance.

9. ENGINEERING

All work to be done to the City of Langley's Design Criteria Manual (DCM), and follow the City's Subdivision and Development Servicing Bylaw (SDSB). Below comments are preliminary. Additional requirements may be required pending professional report, site review & inspections, and detailed review of civil off-site servicing drawing.

Offsite Servicing Requirements:

1. The developer's consulting engineer shall review the site layout to ensure that the parking layout, vehicle circulation, turning paths and access design meet applicable standards and sightline



Subject: Development Permit Application DP 03-25

Page 7

requirements. Appropriate turning templates should be used to prove parking stalls, loading areas and drive aisles are accessible by service vehicles in accordance with Section 8 of the DCM.

- Garbage and recycling enclosures, and collection vehicle access route and turning radius shall be accommodated on the site. Please refer to the City's Subdivision and Development Servicing Bylaw 2021, No. 3126 for more details.
- 3. On-site stormwater management plan for Phase 2 is required. A Qualified Environmental Professional (QEP) must be engaged to implement erosion and sediment control (ESC) in accordance with the City of Langley Watercourse Protection Bylaw #3152, as amended. The ESC plan must address the off-site works. The on-site ESC plan will be required at the Building Permit stage.
- 4. The ultimate location of the proposed northern driveway off 203 Street is currently under review. Traffic impact analysis report may be required upon determination of the final location.
- 5. Pending the ultimate driveway and servicing location design, additional street tree planting along the 203 Street frontage may be required.
- 6. All storm, sanitary, and water connection servicing requirement shall meet currently standards identified in the DCM.
- 7. An updated to the master water and sanitary hydraulic modelling report will be required to ensure City infrastructure can support this development phase. The costs to undertake the water and sanitary modelling will be the responsibility of the Developer.
- 8. Upon acceptance of the servicing drawing package by Engineering, a servicing agreement for this development phase will be issued.

10. FIRE DEPARTMENT COMMENTS

Fire department access for the whole project was reviewed to ensure adequate access was in place for apparatus and firefighters. Fire apparatus access for the whole site must consider access route, including maneuverability, hydrant location and coverage. A construction fire safety plan shall be completed, complete with crane inspection records. A progressive standpipe installation will be required as construction rises. Standpipes will be required to extend to the parkade elevator lobby, beside the parkade gate, and to each rooftop exit stairway. Balcony sprinklers considered highly important and are strongly requested Stairwells act as an area of refuge and should be made as wide as possible (60") All garbage/recycling containers must be stored in a fire rated, sprinklered room, and must be of adequate size to prevent spillover into adjacent area. Marked Exits must not be on a FOB system. A radio amplification bylaw is currently in development and will need to he adhered to. Consideration will be given to the installation of power banks in the storage room lockers for e-bikes charging. A Fire Safety plan and FD lock box (Knox



Subject: Development Permit Application DP 03-25

Page 8

box) will be required before occupancy. Two 4" FDC will be located on concrete pedestal at the front and rear of the building,(one on 203 St, and one on the ring road) not building mounted. exact location to be discussed with the Fire Department at a later date.

11.BUDGET IMPLICATIONS

In accordance with Development Cost Charges Bylaw, 2024, No. 3256 the proposed development is estimated to contribute \$2,549,520.00 in Development Cost Charges (DCCs) to the City.

The owner of the proposed development currently has an active application for BC Housing's Community Housing Fund (CHF) program. If this application is successful, 70% of the building's units would be non-market with rents geared to income of tenants. Under the City's CO-80 Amenity Contributions Policy, this would qualify the building for a full waiver of Community Amenity Contributions (CACs). However, if the development proceeds under a different funding program with a different rental level distribution, CACs may become applicable.

Prepared by:

Ji Woo Lee, BSc., MCRP Planning Assistant II

Concurrence:

Roy M. Beddow, RPP, MCIP Deputy Director of Development Services

Concurrence:

Dand Pollon

David Pollock, P.Eng. Director of Engineering, Parks,

& Environment

Attachments

Concurrence:

Carl Johannsen, RPP, MCIP Director of Development Services

Concurrence:

Scott Kennedy Fire Chief



Subject: Development Permit Application DP 03-25

Page 9



DEVELOPMENT PERMIT APPLICATION DP 03-25


Civic Address: 5470 203 Street

Legal Description: Lot 4 and an Undivided 18/100th Share in Lot 1,

District Lot 36, Group 2, New Westminster District, Plan EPP107406, See Plan as to Limited Access

Applicant: DYS Architecture

Owner: Langley Lions Housing Society

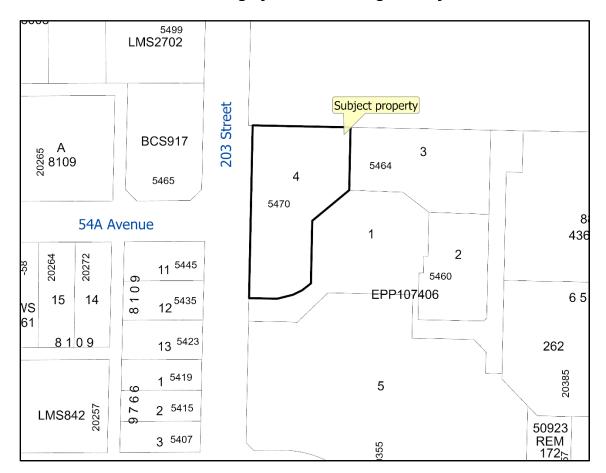





LANGLEY LIONS - ALDER BUILDING REPLACEMENT 5470 203rd STREET LANGLEY BC

ISSUED FOR DP AMENDMENT REVISION 2 2025-09-04

ARCHITI	CTURAL							
						LANDSCAPE		
A0.00	COVER SHEET CONTENTS PROJECT TEAM	NA	A3.01	ELEVATIONS	1/8" = 1'-0"	DP P2-L0.0 DP P2-L0.1	COVER SHEET LANDSCAPE NOTES & SCHEDULES	N/A
A0.01	PROJECT INFO AND STATISTICS	NA	A3.02	ELEVATIONS	1/8" = 11-0"	DP P2-L0.2	LANDSCAPE ILLUSTRATIVE PLAN	NA
A0.02	PERSPECTIVES	NTS	A3.03	ELEVATIONS	1/16" = 1'-0"	DP P2-L1.0	ARBORIST TREE MANAGEMENT PLAN	N/A
A0.03	PERSPECTIVES	NTS				DP P2-L2.0	OFFSITE PLAN	N/A
A0.04	SHADOW STUDY	NTS	A4.01	BUILDING SECTION	1/8" = 1'-0"	DP P2-L3.0	LANDSCAPE MATERIALS PLAN	N/A
A0.05	CONTEXT PLAN	1/32" = 1'-0"	A4.02	BUILDING SECTION	1/8" = 1'-0"	DP P2-L3.1	LANDSCAPE PLAN - ROOF	N/A
A0.06	SUSTAINABLE DEVELOPMENT	N/A	A4.03	BUILDING SECTION	1/8" = 1'-0"	DP P2-L4.0	LIGHTING PLAN	N/A
A0.07	SLIRVEY PLAN	NTS				DP P2-L5.0	LANDSCAPE GRADING & DRAINAGE PLAN	N/A
						OP P2-L6.0	PLANTING PLAN	N/A
A1.01	GITE PLAN	1/10" - 1" 0"				DØ 824 7 0	SOU DEPTH & SERVICING PLAN	NUE
A1.02	FIRE ACCESS PLAN	1/16" = 1'-0"				DP P2-L8.0	LANDSCAPE SECTIONS & ELEVATIONS	N/A
						DP P2-L9.1	DETAILS	N/A
A2.01	PARKING LEVEL 01	1/8" = 1'-0"				DP P2-L9.2	DETAILS	N/A
A2.02	FLOOR PLAN LEVEL 01	1/8" = 1'-0"				DP P2-L9.3	DETAILS	N/A
A2.03	FLOOR PLAN LEWIL 02-06	1/8" = 1'-0"				DP P2-L9.4	DETAILS	N/A
A2.04	FLOOR PLAN LEVEL 07	1/8" = 110"						
A2.05	ELOOR PLAN LEVEL OR	1/8" = 1'-0"						
A2.06	ROOF PLAN	1/8" = 1'-0"						
A2.07	LINIT PLANS	1/4" = 1'-0"						

PROJECT TEAM

CUENT	CODE
Langley Lions Housing Society 5464 203 St.	GHL Consultant 800-700 W Pen
Langley, BC V3A 0A4 T 604 530 7171	Vencouver, BC T 604 689 4449
F 604 530 7104	

dys architecture
260-1770 Burnard Street Vancouver BC V&J 3G7
tel 604 669 7710 www.dysarchitecture.com





LANGLEY LIONS
ALDER REPLACEMENT
5470 203RD ST. LANGLEY BC VSA 0A4

COVER SHEET



PROJECT INFORMATION

	PROJECT NAME:	Langley Lions Master Plan	
	PROJECT ADDRESS:	5470 203 Street, Langley, B.C.	
		_	
A	DESCRIPTION OF PROJECT:		

C. LEGAL DESCRIPTION:
Lot 172, Except: Part on plan 50923 and lots 262 and 263 plan 65845 All of district lot 36 group 2 NWO. PID: 004-219-775

G.	DENSITY (FLOOR AREA RATIO CALCULATION or FLOOR SPACE)	RATIO CALCULATION)					
	DESCRIPTION	DENSITY: RM2	ALLOWABLE	AREA: RM2	DENSITY: CD70	PROPOSED	AREA: CD70
			SF	M		SF	M
	ALLOWABLE FAR	2.000	69,139 SF	6,423 m ²	4.2	145,782 SF	13,544 n
	ADDITIONAL FAR			16			
	TOTAL DENSITY AREA:						
	DENSITY (EXCLUDED FROM FAR):						
	TOTAL DENSITY AREA (W/EXCLUDED AMENITY)					rhd	md .

31.2M (102.3 FT)

PROJECT STATISTICS

			CALCULATION OF NET DENSITY						
LEVEL	GFA (ft²)	GFA (m²)	CIRCULATION (ft ²)	AMENITY (ft ²)	SERVICES (ft²)	NET AREA	BALCONIES	EFFICIENCY	# OF UNITS
Level 1	18309.8	1701.0	3822.4	1787.3	292.1	12408.0	2923.8	68%	
Level 2	10235.3	1004.1	2797.7	116.7	314.4	15006.5	2126.7	82%	
Level 3	18235.3	1694.1	2797.7	116.7	314.4	15006.5	2126.7	82%	
Level 4	18235.3	1694.1	2797.7	116.7	314.4	15006.5	2126.7	82%	
Level 5	18235.3	1694.1	2797.7	116.7	314.4	15006.5	2126.7	82%	
Level 6	18235.3	1694.1	2797.7	116.7	314.4	15006.5	2126.7	82%	
Level 7	18148.0	1686.0	2797.7	116.7	314.4	14919.2	2213.9	82%	
Level 8	18148.0	1686.0	2797.7	116.7	314.4	14919.2	2026.8	82%	
TOTAL	145782.3	13543.6	23406.3			117278.9	17798.0	82%	

UNIT DISTRIBUTION		UNIT TYPES				
LEVELS	1 BED ACC	1 BEDROOM	2 BEDROOMS			
Level 1	1	18	1			
Level 2	1	21	2			
Level 3	1	21	2			
level 4	1	21	2			
Level 5	1	21	2			
Level 6	1	21	2			
Level 7	1	21	2			
Level 8	1	21	2			
TOTAL	8	165	15	1		

ACCESSIBILITY SUMMARY								TOTALS
	REQUIRED	PROVIDED	Name-Type	Location	VBBL	CMHC	BC Housing	
Accessible Units								
		8	Unit A1 - ACC	11-8			×	
Adaptable Units								
		125	Unit 81 - ADP	L1-8		×	×	
		16	Unit B1-C - ADP	L1-8		×	x	16
		12	Unit 81-1 - ADP	L1-6		×	×	12
		2	Unit B1-2 - ADP	1.7		×	x	
		2	Unit B1-2a - ADP	L8		×	×	2
		8	UNIT 82 - ADP	L1-8		×	×	
		8	Unit C1 - ADP	L1-8		×	x	
		7	Unit C2 - ADP	12-8		×	x	7
TOTAL								188

0.	BICYCLE STORAGE SUMMARY							
		REQUIRED	PROVIDED	HORIZONTAL(CLASS I)	VERTICAL (CLASS I)	LOCKERS (CLASSI)	VISITOR (CLASS II)	TOTALS
	94	100	100	94	0	0	6	100

Ρ.	WASTE MANAGEMENT SUMMARY				
	TOTAL VOLUME OF WASTE	# OF CONTAINERS REQUIRED	STORAGE AREA REQUIRED	STORAGE AREA PROVIDED	
	GENERATED	0.000.000.000.000.0000.0000.0000	(ft ²) (m ²)	(ft ²) (m ²)	
		6 240 L	61.0 5.		
		15 360 L	228.9 21.		
		3,058 L	122.1 11.		
	TOTAL WAFTE		412.0 28	620.3 63.3	

AVERAGE GRADE CALCULATION

	Average G	irade Calcu	ilations		
	North	Property L	ine:		
Point 1:	33 '- 1.5 "		33.1 ft	F	10.1 m
Point 2:	33 '- 10.3 "	- 1	33.9 ft	- 1	10.3 m
Average Grade:	33 '- 5.9 "		33.5 ft		10.2 m
	East P	roperty Li	10:		
Point 1:	32 '- 11.4 "		32.9 ft		10.0 m
Point 2:	33 '- 2.3 "		33.2 ft		10.1 m
Point 3:	33 - 1.4 *	-	33.1 ft	-	10.1 m
Average Grade:	33 '- 1.0 "	-	33.1 ft		10.1 m
	South	Property L	ine:		
Point 1:	34 '- 1.2 "	10	34.1 ft	10	10.4 m
Point 2:	31 '- 10.5 "		31.9 ft		9.7 m
Average Grade:	32 '- 11.8 "		33.0 ft		10.1 m
	West	Property Li	ne:		
Point 1:	33 '- 10.3 "		33.9 ft	-	10.3 m
Point 2:	34 ' 3.2 '	- 1	34.3 ft	- 1	10.4 m
Average Grade:	34 '- 0.7 "		34.1 ft	- 1	10.4 m

BUILDING HEIGHT CALCULATION

Duilding Height										
Total Average Grade	33 '- 10.3 "		33.4 ft	10.2 m						
Geodetic Building Height:	135 - 9.0 *	-	135.8 ft	41.4 m						
Building Height:	102 '- 4.1 "		102.3 ft	31.2 m						

UNIT NUMBER AND AREA CALCULATION

UNIT TYPE	ONE BEDROOM (SQF)							TWO BEDROOM (SQF)		
	A (ACCESS.)	B1 (ADAPT.)	B1-C (ADAPT.)	B1-1 (ADAPT.)	B1-2 (ADAPT.)	81-2a (ADAPT.)	B2 (ADAPT.)	C1(ADAPT.)	C2 (ADAPT.)	
UNIT AREA (BCH)	671.4	591.6	589.9	591.6	545.6	545.6	660.1	754.5	743.7	
UNIT AREA W/	690.6	610.4	900.9	902.0	555	509	674.2	773.	764.2	
IN-SUITE STORAGE	25.6	25.3	25.3	28.1			26	25.1		
UNDERGROUND	2.00		-	10.1	25	25			25	
UNIT NUMBER							1			
UNII NUMBER	4.3%	87.8%					8.0%			
TOTAL			165					15		1
	8	125	16	12	- 2	2	8		3 7	1
u	1	13	2	2			1			
L2	1	16	2	2						
L3	1	16	2	2			1		1	
L4	1	16	2	2			1		1 1	
L5	- 1	16	2	2			1		1	
L6	1	16	2	2			1		1	
L/	1	16			172		2		1	
L8	1	16	2			2	1		1	
UNIT AREA	4.7%				-				-	
TOTAL	5524.8		85.9% 100217.45					9.8%		11727
	5524.8 5524.8		9614.4			1118	5393.6			117276
u	690.6	7935.122				1110	674.2			11/2/0
12	690.6	9766.304					674.2			
13	690.6	9766.304					674.2			
14	690.6	9766.304					674.2			
LS	690.6						674.2			
16	690.6	9766.304					674.2			
17	690.6	9766.304			561		674.2			
LB	690.6	9766.304			30.1	1118				
- 18	690.6	9/00.304	1201.6			1118	0/42	773.	709.2	





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NO. | DATE | REVISION



LANGLEY LIONS ALDER REPLACEMENT 5470 203RD ST. LANGLEY BC V3A 0A4

PROJECT INFO AND STATISTICS









2 PEDESTRIAN VIEW - NORTHWEST PERSPECTIVE



PEDESTRIAN VIEW - SOUTHWEST PERSPECTIVE



4 PEDESTRIAN VIEW - SOUTHEAST PERSPECTIVE



LANGLEY LIONS
ALDER REPLACEMENT
5470 203RD ST. LANGLEY BC V3A 0A4

PERSPECTIVES











3) SKY VIEW - SOUTHEAST PERSPECTIVE

SKY VIEW - NORTHWEST PERSPECTIVE



4 PEDESTRIAN VIEW - OUTDOOR AMENITY



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ALDER REPLACEMENT
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PERSPECTIVES





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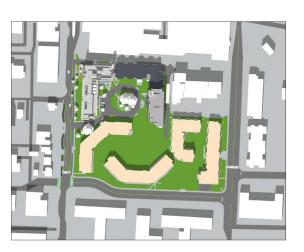
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MARCH 9AM

SEPTEMBER 9AM





SEPTEMBER 12PM SEPTEMBER 3PM



SHADOW STUDY



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NO. | DATE | REVISION 1 | 2022-06-15|FIRE TRUCK ROAD UPDATED



INTERPOLATED GRADE DESIGN SPOT BLEVATION

SYMBOL LEGEND

LAWN BASIN

STORM HANGLE

8

RIGHT OF WAY



LANGLEY LIONS ALDER 5470 203RD ST. LANGLEY BC V3A 0A4

ALDER REPLACEMENT CONTEXT PLAN



PROJECT A217398
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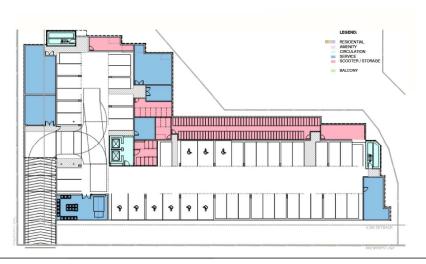
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DATE 9/3/2025

CPTED DESIGN STRATEGIES

- THE BUILDING AND PARKADE HAVE GOOD ACCESS CONTROLS, THERE IS ONLY ONE PEDESTRIAN AND 1 VEHICLE ACCESS POINT, BOTH ARE CONTROLLED ELECTRONICALLY (INTERCOM AND FOB OR PROXIMITY CARD) AND CCTV.
- . THE MAIN ENTRANCE VISUALLY STANDS OUT AND REMOVES EXCUSES FOR LCITERING.
- ALL THE GROUND FLOOR PATIOS WILL BE GATED FOR AN EXTRA LAYER OF ACCESS CONTROL.
- EGRESS ONLY DOORS WILL HAVE DOOR HARDWARE REMOVED FROM THE PUBLIC SIDE.

TERRITORIALITY:

. LANDSCAPE DESIGN PROJECTS OWNERSHIP INTO THE PUBLIC REALM AND THE MAINTENANCE PROGRAM WILL KEEP UP THE BUILDING, LANDSCAPING, OUTDOOR AMENITY AND OUTDOOR FURNITURE.



00 00 00

CPTED LIGHTING GUIDELINES WILL BE INCORPORATED IN THE DESIGN DEVELOPMENT STAGE.

NATURAL SURVEILLANCE:

- THE PATIOS, GLAZING AND BALCONIES CONTRIBUTE TO A STRONG SENSE OF NATURAL SURVEILLANCE
- PARKADE ELEVATOR LOBBY WILL HAVE GLAZING FOR BETTER SIGHT LINES.
- VISION PANELS WILL BE INCLUDED IN PARKADE EGRESS DOORS TO STAIRWAYS.
- · LANDSCAPING WILL BE LOW AND MAINTAINED WHEN MATURE SO IT DOES NOT INTERFERE WITH SIGNAGE OR SIGHT LINES.

00

- · ANTI-GRAFFITI SEALANT WILL BE APPLIED TO ANY EXPOSED CONCRETE SURFACES
- SITE FENCING WILL BE PERMEABLE TO FACILITATE SIGHT LINES.
- GLAZING HAS BEEN INTRODUCED ON THE SOUTH FAÇADE AT THE CORRIDOR TO FACILITATE SIGHT LINES.

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SUSTAINABLE DEVELOPMENT SOCIAL ECONOMY CULTURE

2. ENVIRONMENTAL IMPACT

- · CONSTRUCTION TECHNIQUES DURING DEVELOPMENT INVOLVE MEANS TO PROTECT AIR QUALITY
- CONSTRUCTION TECHNIQUES MINIMIZES SITE DISTURBANCE. SEE SEDIMENTATION AND EROSION CONTROL REQUIREMENTS.
- INCORPORATES GROUND-LEVEL LIGHT POLLUTION REDUCTION PRINCIPLES
- . INCORPORATES DARK SKIES LIGHT POLLUTION REDUCTION PRINCIPLES

- PROVIDES ENHANCES RECYCLING FACILITIES WITH DESIGN FEATURES TO ENHANCE THE ABILITY TO RECYCLE THE FULL RANGE OF RECYCLABLE MATERIALS.
- · INCORPORATES A CONSTRUCTION RECYCLING PLAN. IF APPLICABLE, AN OPERATING RECYCLING PLAN HAS BEEN DEVELOPED
- . INCORPORATES THE USE OF RECYCLED BUILDING MATERIALS (E.G. FROM DEMOUSHED BUILDINGS)

4. STORM WATER MANAGEMENT

- · INCLUDES A MINIMUM OF 30 CM OF TOPSOIL, SEE STORM WATER BEST MANAGEMENT PRACTICES
- . INCORPORATES A STORM WATER MANAGEMENT PLAN INCLUDING A GROUNDWATER RECHARGING SYSTEM (SEE '4D' BELOW), IF APPLICABLE. SEE OCP POLICY 9.2.5. AND 9.2.6
- · WHEN COMPLETED, THE DEVELOPMENT PROTECTS GROUNDWATER FROM CONTAMINATION, SEE STORM WATER BEST MANAGEMENT PRACTICES,
- PROTECTS RECEIVING WATER FROM NON-POINT SOURCE POLLUTION AND PROTECTS AGAINST WATER CHANGES IN BASE FLOWS

5. ENERGY EFFICIENT CONSTRUCTION

· ACHIEVES AN ENERGY PERFORMANCE OF 25% BETTER THAN THE CURRENT MODEL NATIONAL ENERGY CODE FOR MULTI-UNIT RESIDENTIAL BUILDINGS.

6. ENERGY SUPPLY AND CONNECTIVITY

· PROVIDES ON-SITE RENEWABLE ENERGY GENERATION ... HEAT RECOVERY VENTILATION.

- PROJECT DESIGNED TO MEET A GREEN BUILDINGS STANDARD.... (BC ENERGY STEP CODE (8))
- . BEDLICES THE HEAT ISLAND EFFECT WITH. LINDERGROUND PARKING COMMUNITY CARDENS AND PLANTED SHRURS.
- . USES CLIMATE SENSITIVE DESIGN FEATURES (E.G. PASSIVE SOLAR, MINIMIZE THE IMPACT OF WIND, AND RAIN, ETC.)

- . TISES DOVERSHIT TO EDANT BEANTS LIKES VEDISCADING AS A CHINE AND AVOIDS OWED LAMPSCADING
- . USES NON-WATER DEPENDENT MATERIALS IN THE LANDSCAPING DESIGN SUCH AS A MIX OF ROCKS AND OTHER MATERIALS. DOES NOT EXCLUDE THE USE OF INDIGENOUS, DROUGHT TOLERANT PLANTS.
- . INCORPORATES AN IRRIGATION SYSTEM WITH CENTRAL CONTROL AND RAIN SENSORS DESIGNED WITH WATER CONSERVATION IN MIND.

9. BROWNFIELD AND GREYFIELD DEVELOPMENT

10. COMPACT COMMUNITY DESIGN

- . THE DEVELOPMENT IS WITHIN 400 METERS OF PUBLIC TRANSIT OR THE DEVELOPMENT RESULTS IN THE ADDITION OF PUBLIC TRANSIT TO THE AREA
- ENCOURAGES PEDESTRIAN-ORIENTED STREETS.

11. PEDESTRIAN & CYCLING MOVEMENT

- INCLUDES BICYCLING PARKING AND STORAGE LOCKERS OF CYCLISTS. P(LEASE REFER TO ZONING BYLAW 2100
- CREATES GREEN SPACES, OR STRONG CONNECTIONS TO ADJACENT NATURAL FEATURES, PARKS, AND OPEN SPACES.
- . IMPROVES PEDESTRIAN AMENITIES SUCH AS BENCHES, INFORMATION KIOSKS, TRAIL MAPS, ETC. PROVIDES LINKS TO AMENITIES SUCH AS SCHOOL(S), TRAILS, GROCERY STORE, PUBLIC TRANSIT, ETC.

12. RESPONSIBLE TRANSPORTATION

- INCLUDES INFRASTRUCTURE AND DEDICATED PARKING SPACES FOR ELECTRIC PLUG-IN VEHICLES
- . INCLUDES DEDICATED SPACES FOR MOTORCYCLE AND MOPEDS
- CREATES TRANSIT ORIENTATED FACILITIES THAT ADDRESS USER SATISFACTION AND PROVIDES SAFE PICK-UP AND DROP-OFF AREAS.

13. SMART LOCATION

· PROVIDES A VARIETY OF HOUSING IN CLOSE PROXIMITY TO A PUBLIC AMENITY, TRANSIT, OR COMMERCIAL AREA.

14. DIVERSITY OF USE

- PROVIDES A DIVERSITY OF HOUSING TYPES
- · PROVIDES A DIVERSITY OF UNIT SIZES
- · INCLUDES SENIORS HOUSING
- INCLUDES NON-MARKET RENTAL HOUSING

15. SAFE COMMUNITY

- · INCORPORATES CRIME PREVENTION THROUGH ENVIRONMENTAL DESIGN (CPTED) PRINCIPLES
- INCORPORATES PHYSICAL TRAFFIC CALMING IN THE ROAD DESIGN SUCH AS TRAFFIC CIRCLES AND NARROWED INTERSECTIONS.

16 SOCIAL COMMUNITY

- . CREATES OR ENHANCES COMMUNITY SOCIAL GATHERING PLACES (PUBLIC PLAZA, HALLS, MEETING SPACES, ETC.)
- · PROVIDES LAND FOR AMENITIES OR PROVIDES AMENITIES SUCH AS COMMUNITY ACTIVITY OPPORTUNITIES, DAYCARES, RECREATIONAL FACILITIES, ETC.
- PROVIDES AN AREA FOR COMMUNITY GARDENS OR URBAN AGRICULTURE.

17. ECONOMIC STAINABILITY

- . CREATES PERMANENT EMPLOYMENT OPPORTUNITIES AND/OR DENSITIES THAT WOULD ASSIST IN SUPPORTING LOCAL BUSINESSES.

18. CULTURE

. EMPLOYES HIGH QUALITY DESIGN ELEMENTS AND PUBLIC ART TO ADD VIBRANCY AND PROMOTES COMMUNITY VALUES AND IDENTITY.




ALDER REPLACEMENT

SUSTAINABLE DEVELOPMENT







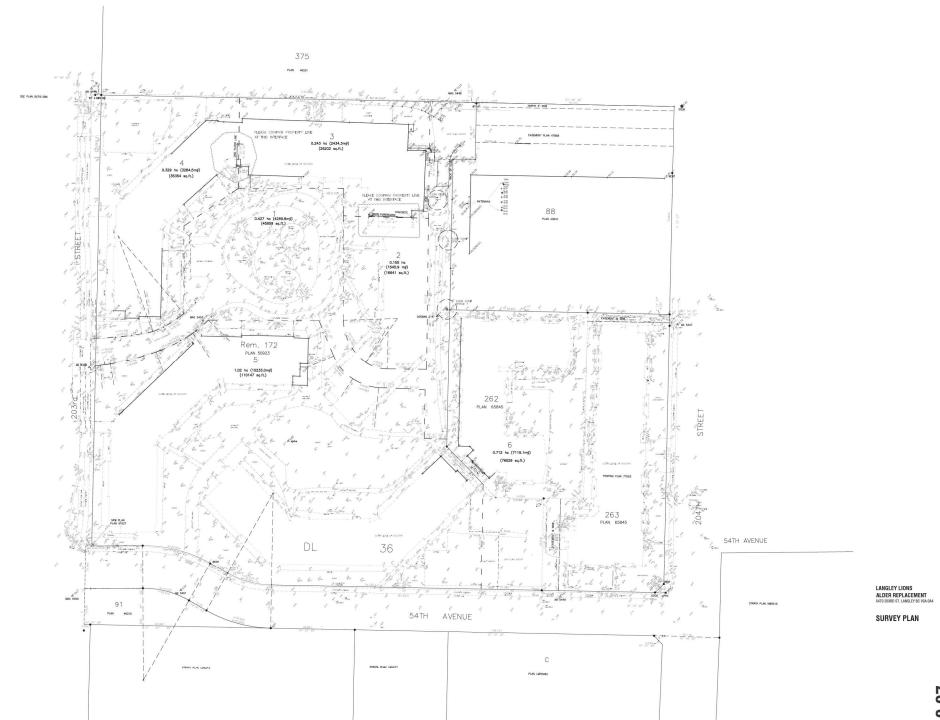

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NO. | DATE | REVISION 1 | 2022-06-15|FIRE TRUCK ROAD UPDATED







LANGLEY LIONS ALDER 5470 203RD ST. LANGLEY BC V3A 0A4

ALDER REPLACEMENT SITE PLAN



1 SITE PLAN

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NO. | DATE | ISSUE
01 | 2020-11-27 | ISSUE FOR DP
02 | 2025-07-16 | ISSUED FOR DP AMENDMENT
03 | 2025-08-27 | ISSUED FOR DP AMEND. RT
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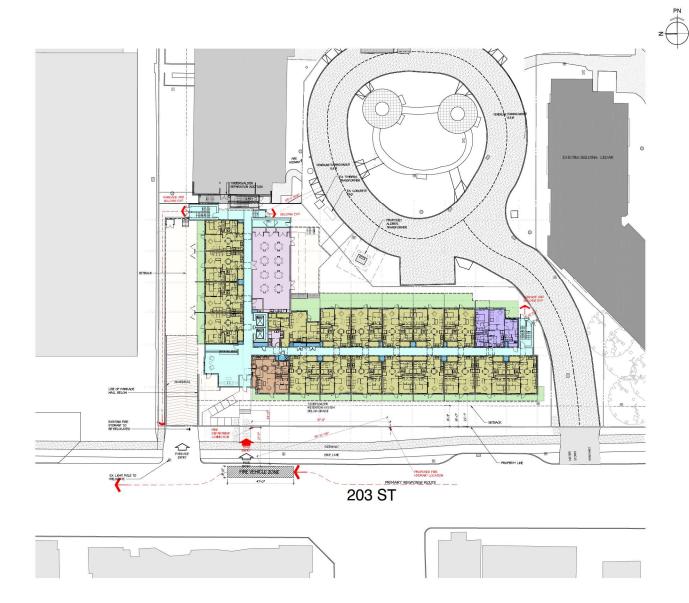



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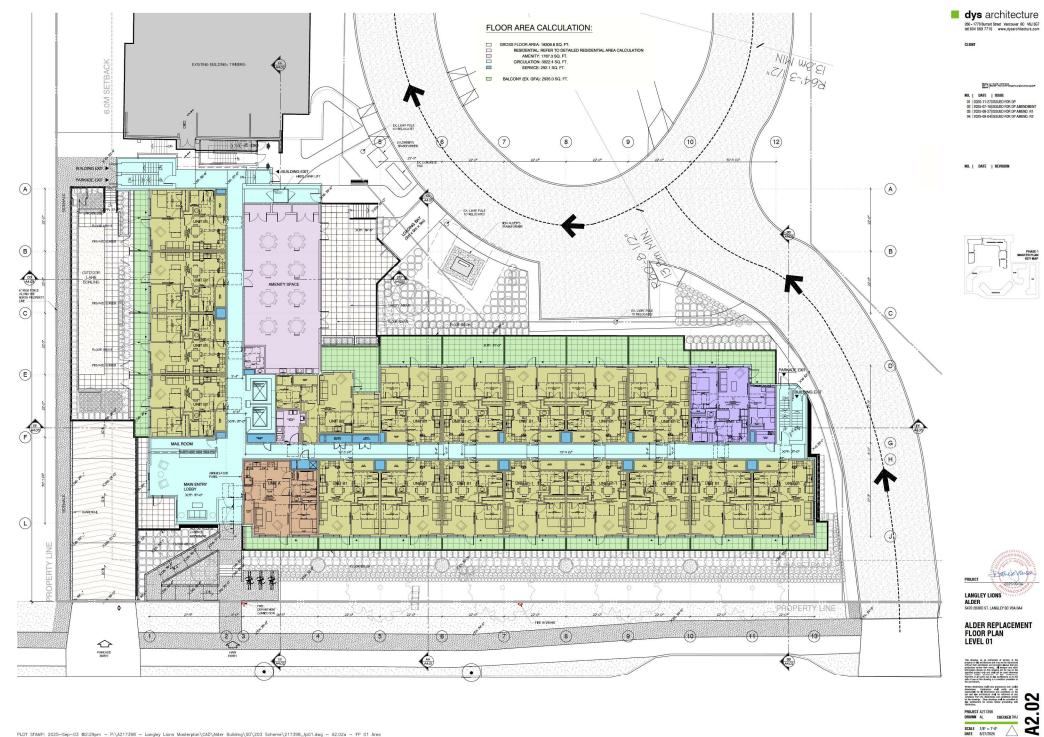


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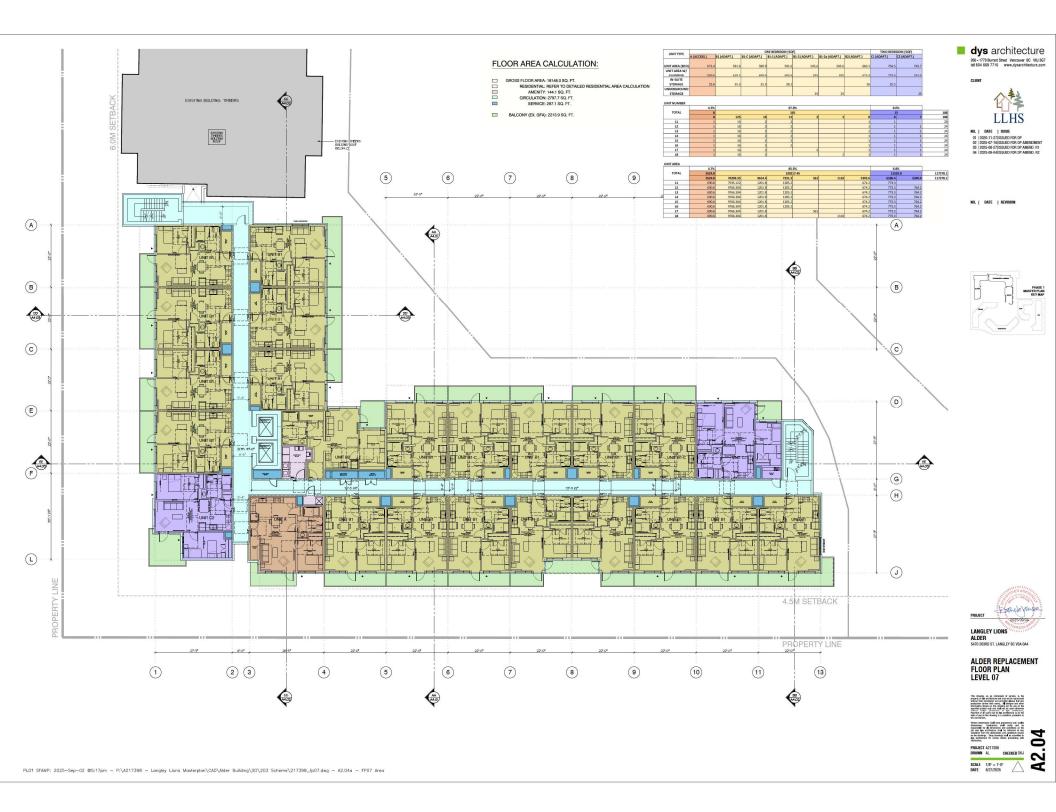
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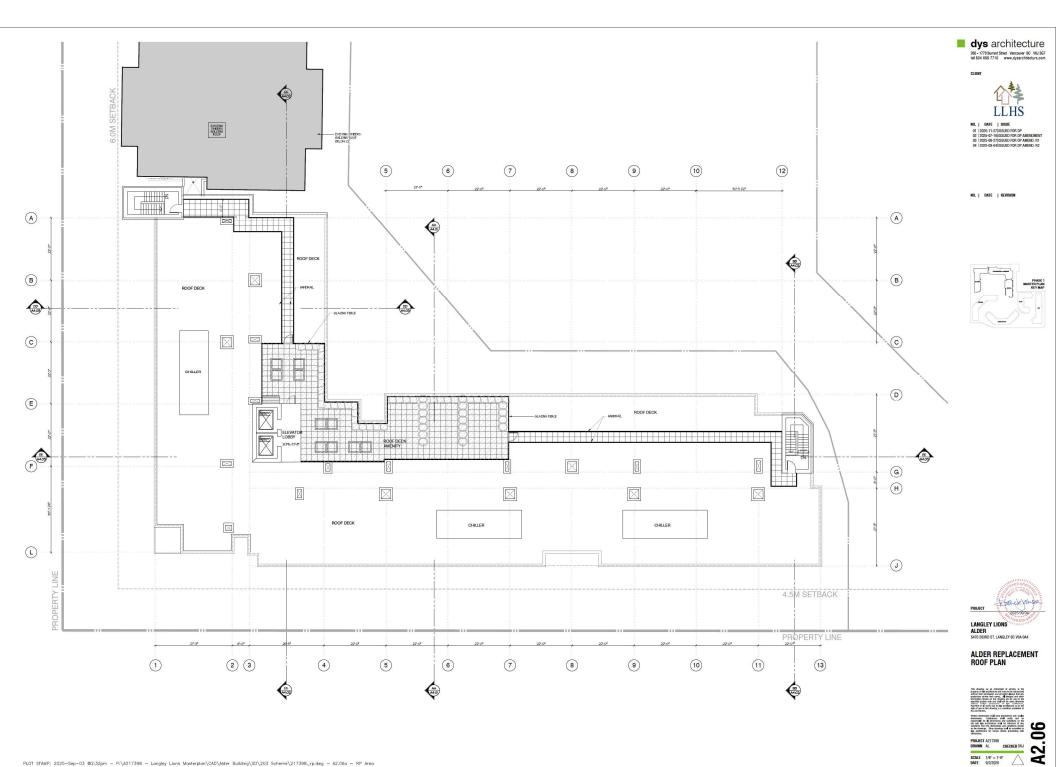








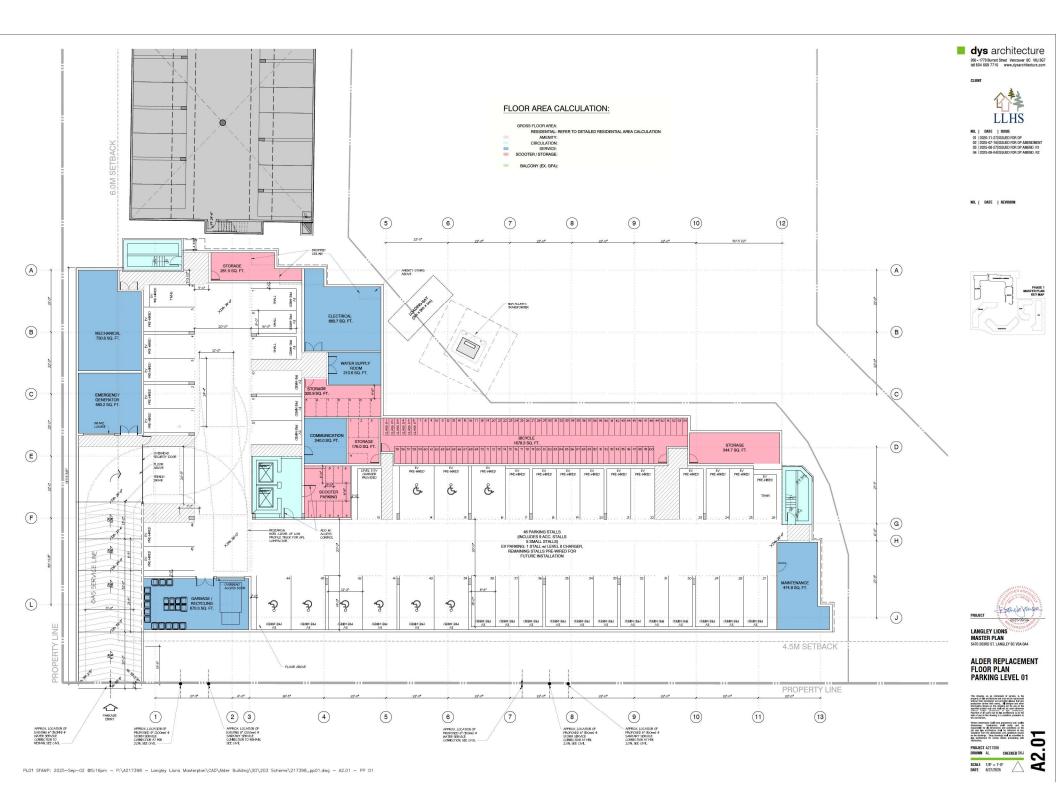



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ALDER REPLACEMENT UNIT PLANS







No. J. State School Separate

NO. | DATE | ISSUE 01 | 2020-11-27 | ISSUE D FOR DP 02 | 2025-07-16 | ISSUED FOR DP AMENDMENT 03 | 2025-08-27 | ISSUED FOR DP AMEND. R1 04 | 2025-09-04 | ISSUED FOR DP AMEND. R2

NO. | DATE | REVISION







4-6 1/4*

UNIT B2

1/47 = 1'-0"
UNIT AFEX 6742 SQ. FT.







ALDER REPLACEMENT UNIT PLANS







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NO. | DATE | REVISION





CERAMIC-COATED FIEER CEMENT SIDING - CASIMERE SHOOTH SILK

Z GERAMIC-COATED FIBER GENERIT SIGNIG - ASHMERE SMOOTH JOKY GRA

(8) CERAMIC-COATED FIBER CEMENT SIDING - CAST STRIPE ASH

4) CERANIC-COATED PIEER CEMENT SIDING - REVEAL SILVER GRAY

5 CERAMIC-COATED FIEER CEMENT SIDNG - REVEAL SAFFICIN

6 CERAMIC-COATED FIBER CEMENT SIDING - BARNADOO LIGHT OAK

1 MINI-REVEAL METAL PANEL (CHARCOAL)

B METAL SOREEN

4 VINTL FRAMED DOUBLE GLAZED HINDON AND DOORS - HITE (ACCENT DOORS 180)

PAINTED CONCRETE

II) DIFFUSED GLASS AND HETAL PRIVACY

(2) ALIMINIM SOLAR SHACING DEVICE

(B) STEEL AND GLASS CANOPY

PREFINISHED ALIMINIM GUARDINAL HITTE CAN DEFUSED GLAZING

tomele prusa LANGLEY LIONS

ALDER 5470 203RD ST. LANGLEY BC V3A 0A4

ALDER REPLACEMENT **ELEVATIONS**

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2 STREETSCAPE



ALDER REPLACEMENT STREETSCAPE







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ALDER REPLACEMENT **BUILDING SECTIONS**

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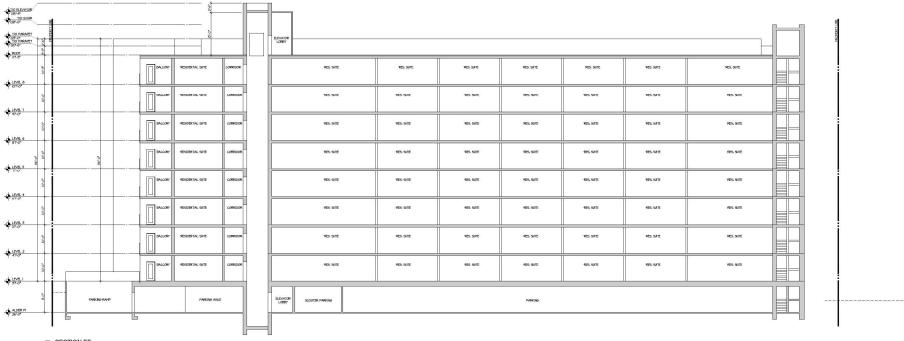
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ALDER
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ALDER REPLACEMENT BUILDING SECTIONS

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Vancouver . BC . Canada . V6J 1H4

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RE-ISSUED FOR DP AMENDMENT

SEPTEMBER 04, 2025

Langley Lions -Alder Replacement for Langley Lions Housing Society

Civic Address: 5470 203rd Street, Langley, BC

B 2025-09-04 Re-issued for DP Amendment

CONSULTANT TEAM

OWNER: LANDSCAPE: ARCHITECT: CIVIL: GEOTECHNICAL: CODE: SURVEYOR: Langley Lions Housing Society ETA Landscape Architecture dys Architecture BINNIE GeoPacific Consultants Ltd. GHL Consultants Ltd Underhill Geomatics Ltd.

Sheet	Drawing	Titl

L0.0	Cover Sheet
L0.1	Landscape Notes & Schedules
L0.2	Landscape Illustrative Plan
L1.0	Arborist Tree Management Plan
L2.0	Offsite Plan
L3.0	Landscape Materials Plan
L3.1	Landscape Plan - Roof
L4.0	Lighting Plan
L5.0	Landscape Grading & Drainage Plan
L6.0	Planting Plan

Soil Depth & Servicing Plan

L8.0 Landscape Sections & Elevations





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Langley Lions Alder Replacement

5470 203rd Street Langley, BC

Cover Sheet

Project Managor M/G	22517
Drawn By Drawn By	NTS
Reviewed By	L0.0

ALL PLANTS TO BE NURSERY GROWN ALL PLANT MATERIALS AND LABOUR TO CONFORM

TO THE CURRENT EDITION OF THE CSLA LANDSCAPE STANDARDS.

ALL PLANT MATERIAL TO BE INSPECTED PRIOR TO DELIVERY ON SITE. CONTRACTOR TO ARRANGE FOR INSPECTION AND MATERIAL TO ASSEMBLED IN ONE LOCATION FOR REVIEW.

IMPORTED GROWING MEDIA SHALL BE A SANDY LOAM OR LOAMY SAND TEXTURE (NO LESS THAN 50% SAND BY WEIGHT) CONTAINING 4 AND 15% ORGANINC MATTER (DRY WEIGHT BASIS).

GROWING MEDIA SHALL VIRTUALLY FREE FROM SUBSOIL, WOOD INCLUDING WOODY PLANT PARTS. INVASIVE AND NOXIOUS PLANT AND THEIR REPRODUCTIBLE PARTS, PLANT PATHOGENIC ORGANISMS, ORGANIC OR INORGANIC MATERIALS, TOXINS, STONES OVER 30mm (1.2°), ANY DEBRIS

IMPORTED GROWING MEDIA SHALL CONFORM TO AND BE TREATED AS PER SECTION 6.2.3 TO 6.2.7 INCLUSIVE OF THE CURRENT EDITION CANADIAN LANDSCAPE STANDARDS.

GROWING MEDIUM SHALL CONFORM TO LEVEL 1 "WELL-GROOMED" AREAS: LOW TRAFFIC LAWN AREAS, TREES AND LARGE SHRUBS (IL IN TABLE T-6.3.5.1 OF THE CURRENT EDITION OF THE CANADIAN LANGEAPE STANDARDS). IT SHALL POSSESS THE FOLLOWING QUALITIES:

TEXTURE

"COARSE GRAVEL (LARGER THAN 19mm AND SMALLER THAN 40mm): 0-196

"ALL GRAVEL (LARGER THAN 2mm AND SMALER THAN 40mm): 0-5%

"SAND (LARGER THAN 0.005mm AND SMALLER THAN 2mm): 50-70%

"SILT (LARGER THAN 0.002mm AND SMALLER THAN 0.05mm): 10-25%

*CLAY (SMALLER THAN 0.002mm): 0-20%
*CLAY AND SILT COMBINED: MAXIMUM 25%

ORGANIC CONTENT: 3-10%

Acidity (nH): 6.0-7.0 as per CANADIAN LANDSCAPE STANDARDS

DRAINAGE: PERCOLATION SHALL BE SUCH THAT NO STANDING WATER IS VISIBLE 60 MINUTES AFTER AT LEAST 10 MINUTES OF MODERATE TO HEAVY RAIN OR IRRIGATION.

MINIMUM SOIL DEPTH TO BE AS PER TABLE T 6.3.5.5 OF THE CURRENT EDITION CANADIAN LANDSCAPE STANDARDS:

subg	prepared rade where the oil drains rapidly	Over structures or where the subsoil drains poorly
LARGE TREE	750mm(30*)	915mm(36")
TREES (10m3 PER TREE)	750mm (30°)	915mm(36")
LARGE SHRUBS	600mm(24")	600-900mm(24"-36")
SMALL SHRUBS	450mm(18")	450-500mm(18*-20*)
LAWN-IRRIGATED	150mm(6")	150mm(6")
LAWN-NOT IRRIGATED	150mm(6")	225mm(9")

SOIL DEPTHS WILL BE CHECKED AT TIME OF SUBSTANTIAL COMPLETION REVIEW

COIL FOR UNDAN AGRICULTURE PLOTS IS TO BE UNDAN GRO PROVIDED BY VERATES, OR APPROVED ALTERNATIVE. SOIL FOR URBAN AGRICULTURE AFRAS IS TO MEET OR EXCEED THE GUIDELINES FOR COMPOST QUALITY UNDER CANADIAN COUNCIL OF MINISTERS OF THE ENVIRONMENT (CCME).

SOIL IS NOT TO BE BLOWN IN FOR INSTALLATION.

COMPOST IS TO BE TESTED AND RESULTS SUBMITTED TO CONSULTANT PRIOR TO DELIVERY TO SITE.

BEDS TO HAVE 3" MULCH LAYER (after settling) CONSISTING OF ORGANIC COMPOSTED BARK APPLIED.

PLANTED AREAS TO HAVE PERMANENT HIGH EFFICIENCY IRRIGATION SYSTEM - SHOP DRAWINGS ARE TO BE PREPARED BY AN IABC CERTIFIED DESIGNER AND APPROVED BY LANDSCAPE ARCHITECT.

CONTRACTOR TO PROVIDE MAINTENANCE FOR 1 YEAR FOLLOWING SUBSTANTIAL COMPLETION.

CONTRACTOR TO PROVIDE WRITTEN 1 YEAR WARRANTY ON PLANT MATERIAL

CONTRACTOR TO PROVIDE COPY OF SOIL TEST TO LANDSCAPE CONSULTANT 3 WEEKS PRIOR TO DELIVERY ON-SITE. TEST TO BE PERFORMED BY AN INDEPENDENT LAB AND IS TO INCLUDE RECOMMENDATIONS FOR BOTH LAWN AND PLANTING BEDS.

CONSULTANT TO APPROVE SOIL BEFORE INSTALLATION. THIS DOES NOT PRECLUDE THE CONSULTANT FROM PERFORMING AN INDEPENDENT SOIL ANALYSIS AT TIME OF SUBSTANTIAL COMPLETION. CONTRACTOR WILL BE RESPONSIBLE FOR REMOVAL AND REPLACEMENT OF SOIL THAT DOES NOT MEET SPECIFICATIONS AT NO EXTRA COST TO CLIENT.

CONTRACTOR TO PROVIDE WRITTEN 1 YEAR WARRANTY ON SOIL SPECIFICATIONS

AN INDEPENDENT SOIL TEST TO BE PROVIDED 1 WEEK PRIOR TO END OF 1 YEAR WARRANTY PERIOD CONTRACTOR TO PROVIDE SOIL AMMENDMENTS TO BRING SOIL UP TO QUALITY RECOMMENDED IN SOILS REPORT.

SITE INSPECTION EXAMINE EXISTING SUBGRADE CONDITIONS AND SIGNIFY ACCEPTANCE IN WRITING TO THE

CONSULTANT. ASCERTAIN THE SIZE AND LOCATION OF ALL EXISTING SERVICES AND SUBGRADES PRIOR TO THE

IMMEDIATELY REPAIR DAMAGE RESULTING FROM FAILURE TO EXERCISE SUCH PRECAUTIONS AT NO COST TO THE OWNER.

ALL PRUNING TO BE IN ACCORDANCE WITH THE CSLA LANDSCAPE STANDARDS CURRENT EDITION.

ALL SOFTSCAPE AREAS ON SLAB TO INCLUDE MIN. 75MM GRAVEL DRAINAGE LAYERS IN ADDITION TO INDICATED SOIL DEPTH.

PLANT COUNTS
IN THE CASE OF ANY DISCREPANCY BETWEEN PLANT COUNTS ON PLANT LIST AND PLANT
SYMBOLS ON DRAWING, THE DRAWINGS TAKES PRECEDENT. THE CONTRACTOR IS TO VERIFY
ALL PLANT COUNTS AND NOTIFY CONSULTANT OF ANY DISCREPANCY.

BIRD FRIENDLY PLANTING
PLANTS THAT ENGLE BIRD FRIENDLY HABITAT CONSERVATION AND POMONITION HAVE BEEN
SELECTED AND CAN BE FOUND THROUGHOUT THE LANDSCAPE. P. ANTING IS GROUPED IN
SELECTED AND CAN BE FOUND THROUGHOUT THE LANDSCAPE. P. ANTING IS GROUPED IN
THE DEAL ENVIRONMENTAL COMMITTIONS FOR BIRDS. THESE LAYERS MULL BE WARRED WITHAUTH
DEVELOPMENT OF TEXTURES AND DENSITIES THAT ATTRACTS AND PROTECTS MANY BIRD SPECIES.
SPECIFIC LOCAL AND INAN INANSIA PLANT SECRED KHAVE BEEN SELECTED BASED ON THEIR
ABILITY TO PROVIDE YEAR-ROUND FOOD FOR BIRDS ANDIOR YEAR ROUND NESTING
OPPORTUNITIES.

GENERAL NOTES

1. DIO NOT SCALE DIRECTLY FROM DRAWNISS.
2. WHERE PLANS AND SECEPICATIONS ARE FOUND TO BE IN CONFLICT, OR WHERE VARIOUS
TIEMS OF WORKER SECHT DIS BE IN CONFLICT, NOTIFY THE CONSULTANT IN WRITING
THEMS OF WORKER SECHT DIS BE IN CONFLICT, NOTIFY THE CONSULTANT IN WRITING
3. THE CONTRACTOR IS REQUIRED TO INVESTIGATE AND VEREY THE ALIGNMENT AND LOCATION
OF ALL DESTING SENDEDS AND ALL DESTING LANDSCAPE FEATURES ON SITE PRIOR TO
ALL DESTING SENDEDS AND ALL DESTING LANDSCAPE FEATURES ON SITE PRIOR TO
ALL DESTING OF THE PRIOR TO THE PRIOR

COMMENCEMENT OF LANDSCAPE WORKS. MOCK UPS MAY BE REQUIRED AS NOTED/REQUESTED 5 DIMENSIONS ON THIS DRAWING ARE IN MM, UNLESS OTHERWISE STATED AS REQUIRED BY THE

CITY.

6. THESE DRAWINGS SHOULD BE READ IN CONJUNCTION WITH CORRESPONDING ARCHITECTURE.

6. THESE PARAMINGS SHOULD BE READ IN CONJUNCTION WITH CORRESPONDING ARCHITECTURE.

7. VERIFY LOCATION OF ALL MULENGROUND STRUCTURES INCLUDING, BUT NOT LIMITED TO,

WALTS, ELECTRICAL DUCT BANKS, BAMHOLES, COOLING AND PIPMS, DARRIANGE STRUCTURES.

8. ALL VEHICULAR ROADS SIDE AVERS TO BE READ FROM (ECTIC-KINCAL SPECIFICATIONS.

9. THE CONTRACTOR IS RESPONDING FOR REPAIRING ALL WORN DISTURBED BY CONSTRUCTION

TO ACCOMPLICATION OF CONTRACTION OF THE ASSISTING CONDITIONS PRICE TO

TO ACCOMPLICATION OF CONSTRUCTION AND ADDITIONAL COST TO THE CONFIDENCE.

10. FOR PASSED PROJECT, A SOIL, TEST SUMMITH, WILL BE RECOURED AT EACH PHASE AND THE

TEST IS TO BE WITHIN AS VIEWS OF THE EACH PROJECT OF THE ACCOUNTED AT EACH PHASE AND THE

TEST IS TO BE WITHIN AS VIEWS OF THE EACH PROJECT OF THE CONTRACT OF THE ACCOUNTED AT EACH PHASE AND THE

TEST IS TO BE WITHIN AS VIEWS OF THE EACH PLANE OF THE COLUMNITY OF THE CONTRACT OF THE CONTRACT OF THE COLUMNITY OF T

TEST IS TO BE WITHIN 3 WEEKS OF THE DELIVERY TO SITE.

PLANTINA ORDS. REFER TO CURRENT NOTES LIST.

1 THE CONTRACTOR SHALL INSTALL TIRE PROTECTION FENCE AS INDICATED ON THE DRAWINGS OF ARBIDIST REPORT IN COMMUNICATION HALL MINICIPAL MAD PROFESSIONAL REQUIREMENTS.

3 DO NOT STORE CONSTRUCTION MATERIALS, DEBRIS, EXCANTED MATERIAL OR EQUIPMENT WITHIN TREE PROTECTION ZONE.

3 DO NOT STORE CONSTRUCTION MATERIALS, DEBRIS, EXCANTED MATERIAL OR EQUIPMENT WITHIN THE PROTECTION ZONE.

BEYOND THE DEPLY LIKE ELECTRON OF PROTECTED THESE 0.5M OR (20 IN-CHES) BEYOND THE DEPLY LIKE ELECTRON OF PROTECTED THESE 0.5M OR (20 IN-CHES) BEYOND THE DEPLY LIKE ELECTRON OF PROTECTED THESE 0.5M OR (20 IN-CHES) BEYOND THE DEPLY LIKE ELECTRON OF PROTECTED THE DEBRIS OF THE DEB

RECOMMENDATIONS FOR PREPARATION OF GOVERNING REJUMN TO MEET THE STATANA'S CHILD.

RECORDS SOLD FROM LANDSCAPE GRADING IS TO BE REMOVED AND DISPOSED OF OFFSITE BY
THE CONTRACTOR IN A LOCATION APPROVED BY THE DEPARTMENTAL REPRESENTATIVE

BY THE CONTRACTOR IN A LOCATION APPROVED BY THE DEPARTMENTAL REPRESENTATIVE

BY THE STATE OF THE LIST OF SPECIES, INCLUING SEE AND FORM MO OTHER

ID CONTRACTOR TO GISTAN APPROVIA. OF LANDSCAPE ARCHITECT FOR ANY SUBSTITUTIONS OF

THAT THE STATE OF THE CONTRACTOR STALL PROVIDE ROOT BARRIERS FOR ALL TREES LOCATED WITHIN TWO

12. THE CONTRACTOR STALL PROVIDE ROOT BARRIERS FOR ALL TREES LOCATED WITHIN TWO

12. ON HETERS OF PANION OR UNDERGROOT BARRIERS FOR ALL TREES LOCATED WITHIN TWO

12. ON HETERS OF PANION OR UNDERGROOT BARRIERS FOR ALL TREES LOCATED WITHIN TWO

12. ON HETERS OF PANION OR UNDERGROOT BARRIERS FOR ALL TREES LOCATED WITHIN TWO

14. OF PLANTING SOLD PROVIDED HOW THE CONTRACTION SYSTEMS

NECESSARY TO WATER AND MAINTAIN PROPOSED AND EXISTING VEGETATION.

14. FOR PLANTING SOLD PETH FOLDOW THE CITY SECONMENDATION AND REQUIREMENTS ONLY IT HE CITY'S REQUIREMENTS FOR SOLD DEPTH EXCEDS COSALOR BOSIS AND ARROWS AND

ONLY IF THE CITY'S REQUIREMENTS FOR SOLD DEPTH EXCEDS COSALOR BOSIS AND ARROWS AND

REQUIREMENTS

IT A SHOP DRAWING INDICATING THE SOIL DEPTH TO BE PROVIDED FOR THE LANDSCAPE REVIEW PRIOR TO INSTALLATION.

IS LIGHT-WEIGHT-BLOWN-IN SOIL WILL NOT BE ACCEPTED UNLESS IT IS REQUIRED BY STRUCTURAL ENGINEER.

IT A LANDSCAPE ARCHITECT SHALL BE ON SITE AT SOIL DELIVERY DATE.

HARD LANDSCAPE & FURNITURE NOTES

1.PROVIDE DOPANSION JOINTS ALIGNED WITH PROPOSED PAVING PATTERN AND DAVING1.PROVIDE DOPANSION JOINTS ALIGNED WITH PROPOSED PAVING PATTERN AND DAVING1.PROVIDED TO THE PART OF THE PART O

HARDSCAPE MATERIAL PAVING, CLADDING AND CAPPING SHOWING PATTERNS, EXACT DIMENSIONS AND DRAWAGEMENT OF LANDSCAPE ACCIDITECTS APPROVANINGS AND DIMENSIONS AND DRAWAGEMENT OF LANDSCAPE ACCIDITECTS APPROVANINGS AND SPECIFICATIONS OR AS APPROVED BY THE LANDSCAPE ARCHITECTS ON DRAWINGS AND SPECIFICATIONS OR AS APPROVED BY THE LANDSCAPE ARCHITECTS AND DRAWINGS AND SPECIFICATIONS OF LANDSCAPE MATERIALS AS SPECIFICATIONS AND SPECIFICATIONS OF DRAWINGS AND SPECIFICATIONS OF LANDSCAPE INSTALLATIONS.

MOCKLEPS COLUD STAY AS PART OF THE OVERALL HARDSCAPE INSTALLATIONS.

6.ALL SITE FURNITURE COLORS AND FINISHES IS AS INDICATED ON DRAWINGS AND SPECIFICATIONS.

6.ALL SITE FURNITURE COLORS AND FINISHES IS AS INDICATED ON DRAWINGS AND SPECIFICATIONS.

7. CONTRACTOR TO FOLLOW MANUFACTURE RESCONMENDATIONS FOR INSTALLATION AND FIXALION OF ALL SITE FURNITURE AND TO SUBMIT SHOP DRAWINGS FOR LANDSCAPE.

8.ALL SITE FURNITURE COLORS AND FINISHES AS AND CATED ON DRAWINGS AND SPECIFICATION OF ALL SITE FURNITURE COLORS AND FINISHES.

SITE LAYOUT & GRADING NOTES

1 ALL PROPOSED DIMENSIONS SHALL BE VERIFIED ON SITE BEFORE PROCEEDING WITH

CONFERNOTION

ON THE OFFICE OF THE OWNER OF THE OWNER OF THE OWNER OF THE OWNER O

CONSTRUCTION. 4. STAIRS NUMBERS AND RISERS HEIGHT SHOULD BE VERIFIED ON SITE AND ADJUSTED AS SEEN NECESSARY AND AS APPROVED BY ENGINEER. NECESSARY AND AS APPROVED BY ENGINEER.

SOMITACION TO CROSS CHECK ALL EXTERNAL WORKS LEVELS WITH EXISTING BUILDINGS ANY DISCREPANCES TO BE SUBMITTED FOR THE LANDSCAFE ARCHITECTS FEEDBACK.
TO FROM THE PROVINCE AND THE PRINCE AND ASSOCIATED DRAWNESS EFFER TO ENGINEERS DRAWNISS AND SPECIFICATIONS.
BIT FIRST STATEMENT OF PRINCE AND ASSOCIATED DRAWNISS AND SPECIFICATIONS.
BIT FIRST STATEMENT OF PRINCE AND ASSOCIATED DRAWNISS AND SPECIFICATIONS.
BIT FIRST STATEMENT OF PRINCE AND ASSOCIATED DRAWNISS AND SPECIFICATIONS.

IRRIGATION NOTES

1. INGI JEFFLIGHON (JRRIGATION SYSTEM TO BE PROVIDED FOR ALL SOFT LANDSCAPE AREAS SHOWN ON THE DRAWING, BY LANDSCAPE CONTRACTOR.

SHOWN ON THE DRAWING, BY LANDSCAPE CONTRACTOR.

SHOWN ON THE DRAWING, BY LANDSCAPE CONTRACTOR.

JUST PROVIDED (17) 2". CONSTRUCTION TO THE STUB OF THE CONTRACTOR.

LANDSCAPE REVEW AT LEAST ONE WEEK PRIOR TO INSTALLATION AND AS BUILD DRAWING. BY LANDSCAPE STORE AND ASSOCIATED TO THE WEEK PRIOR TO INSTALLATION AND AS BUILD DRAWING. BY LANDSCAPE STORES, FLC VALVE BOOKS TO BE LOCATED IN LOW-VISIBLE PLANTED AREAS ONLY AND LOCATIONS TO BE APPROVED.

JUST LAVIE BOOKS, FLC VALVE BOOKS TO BE LOCATED IN LOW-VISIBLE PLANTED AREAS ONLY AND LOCATIONS TO BE APPROVED.

ALL BRIGATION OF THE ASSOCIATED THE WORK MUST HAVE MINIMUM (5) FIVE YEARS DOWN AND AND ASSOCIATE STRONGARDS.

4. BRIGATION CONTRACTOR PERFORMING THE WORK MUST HAVE MINIMUM (5) FIVE YEARS DOWN AND AND ASSOCIATE STRONGARDS.

5. BRIGATION TO CONFORM TO ALL LOCAL PLUMBING AND ELECTRICAL CODE REQUIREMENTS.

6. BRIGATION TO CONFORM TO ALL LOCAL PLUMBING AND ELECTRICAL AND ELECTRICAL CONTRACTOR IS RESPONSIBLE FOR COCORDINATION WITH MECHANICAL AND ELECTRICAL.

6. BRIGATION TO CONFORM TO BE BEST PER MECHANICAL PLANS.

7. SEPARATE ZORA AND REQUIRED SLEEVES TO BE PROVIDED FOR SPRAY IRRIGATION OF THE STRONGARD AND PERCHANICAL PRIOR OF THE MINISTER OF TH IRRIGATION NOTES

1. HIGH EFFICIENCY IRRIGATION SYSTEM TO BE PROVIDED FOR ALL SOFT LANDSCAPE AREAS

LANDSCAPE LIGHTING HOTES

1. ALL LIGHTING FORTS SHOWN ON LANDSCAPE PLANS ARE FOR REFERENCE ONLY FOR ALL LIGHTING FORTIS SHOWN ON LANDSCAPE PLANS ARE FOR REFERENCE ONLY FOR ALL LIGHTING FORTISES AND TYPES REFER TO ELECTRICAL DRAWNINGS AND SPECIFICATIONS.

PRIOTOMETRIC 5 TO THE LANDSCAPE ARCHITECT FOR REVIEW AND APPROVAL PRIOR TO INSTALLATION ON SITE.

INSTALLATION ON SITE.

SPECIFICATIONS.

SPECIFICATIONS:

A LIGHTING SPECS TO BE COORDINATED AND REVIEWED WITH ELECTRICAL PRIOR TO

LIGHTING SPECS TO BE COORDINATED AND REVIEWED WITH ELECTRICAL PRIOR TO

STREET TREES AND FURNISHINGS TO BE LOCATED AT ACCEPTABLE OFFSITE- REFER TO LAYOUT

DRAWINGS AND MINICIPAL YSTANDARDS

D	QTY	LATIN NAME	COMMON NAME	SPACING	SIZE	NOTES	ATTRIBUTES
TREES							
Acpf	3	Acer circinatum 'Pacific Fire'	Pacific Fire vine maple	as shown	6cm cal/B&B	full/ bushy canopy	N, W
Aro	4	Acer rubrum 'October Glory'	October Glory red maple	as shown	6cm cal/B&B	full/ bushy canopy	P, S
Bn	3	Betula nigra	river birch	as shown	6cm cal/B&B	full/ bushy canopy	N,W,B,P
Mgd	3	Magnolia 'Daybreak'	Daybreak magnolia	as shown	6cm cal/B&B	full/ bushy canopy	
SHRUI	BS / GR	OUNDCOVERS / PERENNIALS					
Carmf	6	Cornus sanguinea 'Midwinter Fire'	Midwinter Fire dogwood	0.91	#5 cont.	full/ bushy plants	w
Osk	124	Cornus sericea 'Kelseyi'	dwarf red osier dogwood	0.61	#3 cont.	full/ bushy plants	N, B, P, W
Osp	3	Corylopsis spicata	winter hazel	1.07	#7 cont.	full/ bushy plants	P, W
Oo O	26	Daphne odora	fragrant daphne	0.76	#2 cont.	full/ bushy plants	E, W
)re	74	Dryopteris erythrosora	autumn fern	0.46	#2 cont.	full/ bushy plants	E
leh	32	Helleborus x hybridus 'Royal Heritage'	hellebore	0.46	1.2m ht/B&B	full/ bushy plants	E, W, P
lma	4	Hydrangea macrophylla	bigleaf hydrangea	1.07	#7 cont.	full/ bushy plants	
ah	200	Lavandula angustifolia 'Hidcote Blue'	Hidcote Blue lavender	0.51	#2 cont.	full/ bushy plants	E, P, Ed
is	276	Liriope spicata	creeping lily turf	0.36	#1 cont.	full/ bushy plants	E, B, P
р	130	Lonicera pileata	box leaf honeysuckle	0.76	#2 cont.	full/ bushy plants	E, B, P
Rfdh	73	Rosa 'Frau Dagmar Hastrup'	Frau Dagmar Hastrup rose	8.0	#2 cont.	full/ bushy plants	B, P
Ryc	31	Rhododendron yakushimanum 'Crete'	Crete rhododendron	0.76	#5 cont.	full/ bushy plants	E. P
Sr	22	Sarcococca ruscifolia	sweet box	0.76	1.2m ht/B&B	full/ bushy plants	E, B, P
ſmh	243	Taxus x media 'Hillii'	Hill's yew	0.61	1.2m ht/B&B	full/ bushy plants	E
	0			C			
LAWN				L.			_
	-	Non-Netted, grown on sand					
NOTES	5	1	1				_

1	ALL LANDSCAPE TO CONFORM TO THE CURRENT EDITION OF THE CSLA STANDARDS FOR LEVEL 1 'GROOMED' LANDSCAPE TREATMENT IN THE EVENT
O	F A DISCREPANCY BETWEEN THE PLANT LIST AND THE PLANTING PLAN, THE PLANTING PLAN TAKES PRECEDENCE.
2	SEARCH AREA TO INCLUDE BRITISH COLUMBIA, WASHINGTON, AND OREGON

N - NATIVE E - EVERGREEN B - BIRD FRIENDLY P - POLLINATOR Ed - EDIBLE W - WINTER INTEREST - VERY SUITABLE/SUITABLE AS PER URBAN TREE LIST FOR METRO VANCOUVER IN A CHANGING CLIMATE

4 IN THE CASE OF ANY DISCREPANCY BETWEEN PLANT COUNTS ON PLANT LIST AND PLANT SYMBOLS ON DRAWING, THE DRAWINGS TAKES PRECEDENT. THE CONTRACTOR IS TO VERIFY ALL PLANT COUNTS AND NOTIFY CONSULTANT OF ANY DISCREPANCY.

TIC	E FURNIS	LINGS							
D		DESCRIPTION	SIZE	COLOUR	MATERIAL	MODEL	MANUFACTURER	OTY	NOTES
1	2/L9.3	Bike Rack	-	Black	Metal. Powder Coated	Staple	Urban Rack	3	
2	3/1.9.3	Bench	-	-	-	-	-	-0.	
3	1/L9.3	Metal Planter	3'-6" x 19'-6" x 2'-3"	Tuscan	Aluminum		C3 Planters	1	
5		Urban Agriculture Planter	4'-0" x 4'-0" x 3'-0"	Natural	Cedar	Elevated Heirloom	Life Space Planters	10	
6		Potting Table	6"-0" x 3'-0" x 3'-0"	Natural	Cedar	Custom	Custom	1	
		Metal Arbor	le .	Natural	Cedar		Custom	1	
8	6/L9.4	Table (Large)	36" Dia			Blue	Maglin	1	
9	5/L9.4	Table (Small)	30" Dia				Maglin	- 4	
10	4/L9.4	Chair	6	,			Maglin	12	
11	2/L9.4	Lounge Couch	57" Width	Diva Night	Aluminum	Vienna Love Seat	Ratana	2	
1	1/L9.4	Lounge Chair	32.5" Width	Diva Night	Aluminum	Vienna Club Chair	Ratana	- 4	
13	3/L9.3	Coffee Table	40" Dia	Ash Grey	Aluminum	Lucia Round Coffee Table	Ratana	2	
		1	P						
	TERIALS								
	DETAIL	DESCRIPTION	SIZE	COLOUR	PATTERN	MODEL	MANUFACTURER	QTY	NOTES
11	2/L9.1	Pedestrian Concrete	4'-0" x 4'-0" Sawcut	Natural			_		Broom Finish
Λ2	4/L9.1	Slab Paver	2"-0" x 2"-0" x 2"	Charcoal	Stack Bond	Manhattan	Newstone		On Pedestal

NOTE: IN THE EVENT OF A DISCREPANCY BETWEEN THE SITE FURNISHINGS, MATERIALS, AND LIGHTING SCHEDULE QUANTITIES AND THE LANDSCAPE PLANS, THE LANDSCAPE PLANS TAKE PRECEDENCE

Date Issue Notes

B 2025-09-04 Re-issued for DP Amendment





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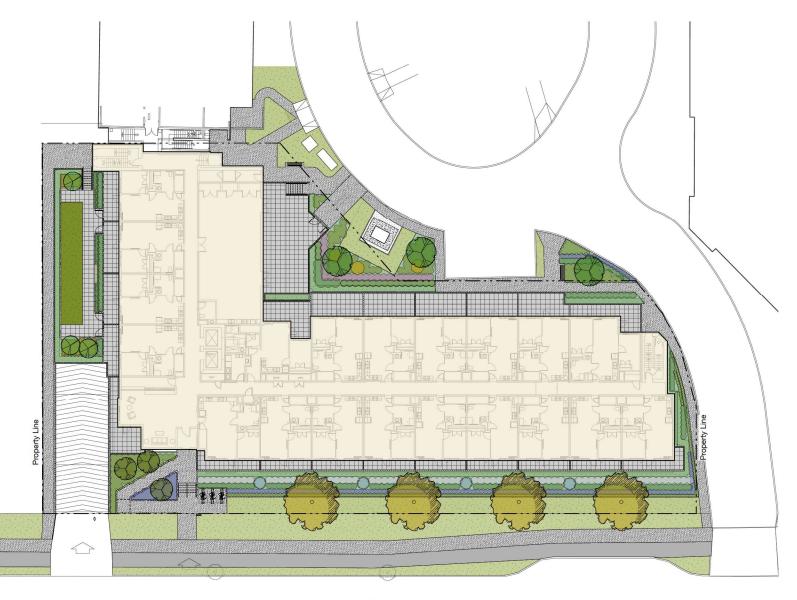
Langley Lions Alder Replacement

5470 203rd Street Langley, BC

Drawing Title

Landscape Notes & Schedules

Project Manager MG	22517
Drawn By Drawn By	Scale NTS
Reviewed By	L0.1
	19



206 St



 No.
 Date
 Issue Notes

 A
 2025-07-29
 issued for DP Amendment

 B
 2025-09-04
 Re-issued for DP Amendment




Langley Lions Alder Replacement


5470 203rd Street Langley, BC

Landscape Illustrative Plan

Project Managor M/G	22517
Drawn By Drawn By	As Noted
Reviewed By	L0.2

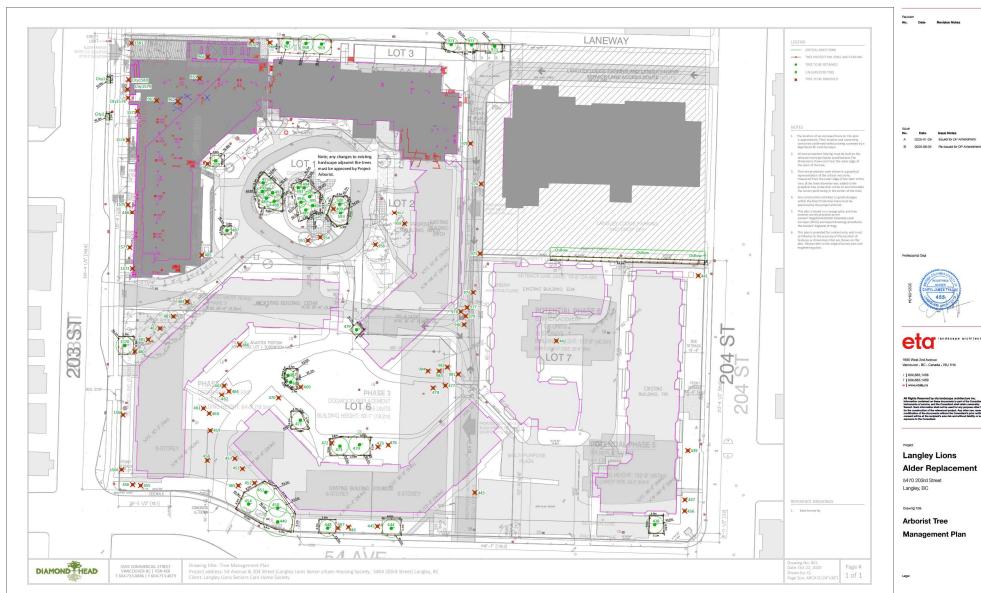

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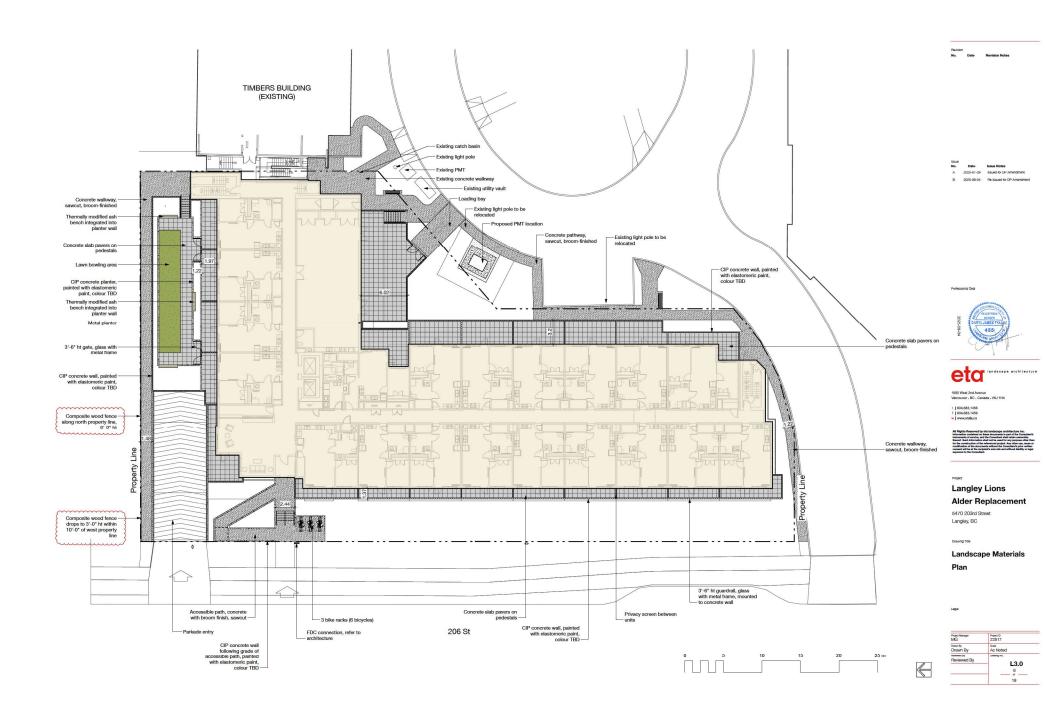
Langley Lions Alder Replacement

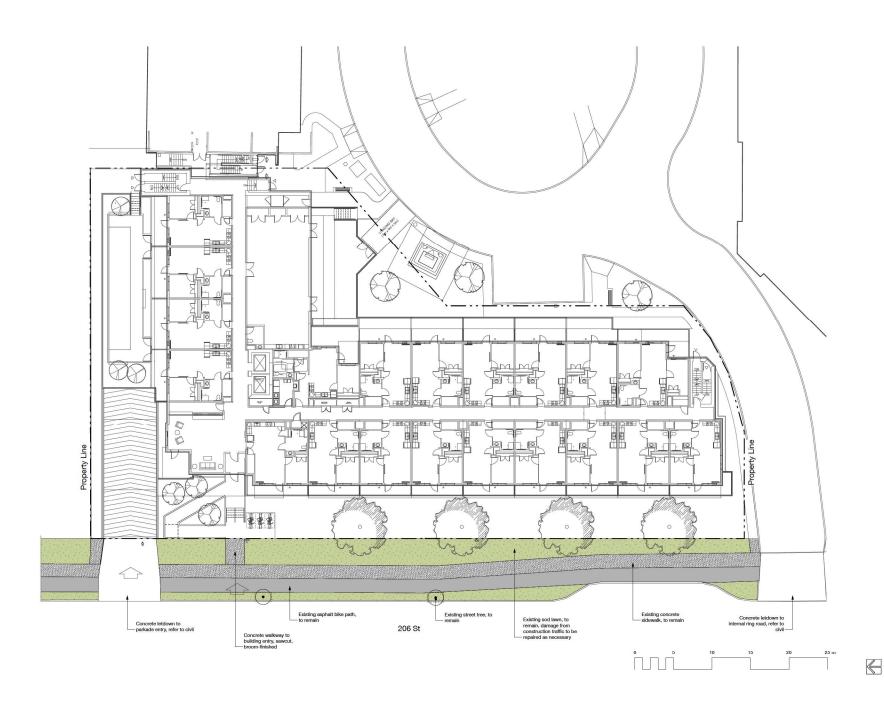
5470 203rd Street Langley, BC

Drawing Title

Offsite Plan

Project Manager MG	22517
Drawn By Drawn By	Scale As Noted
Reviewed By	L2.0



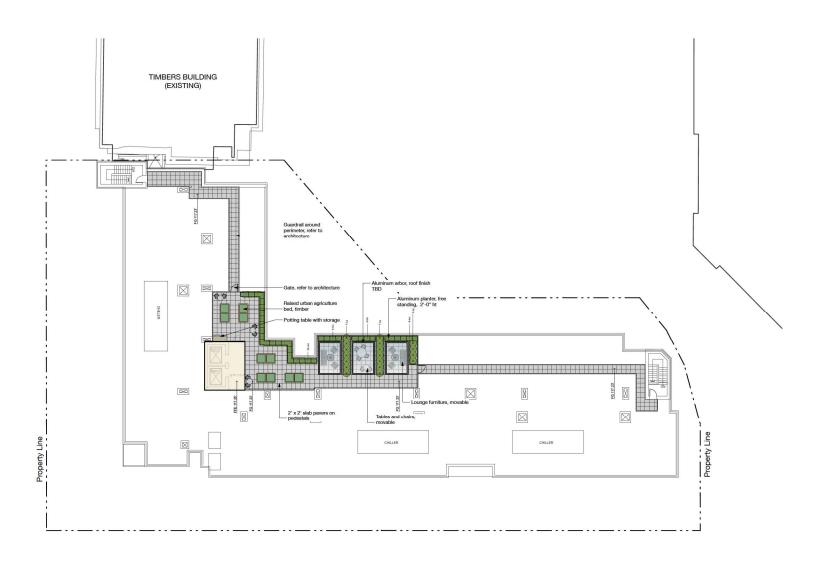



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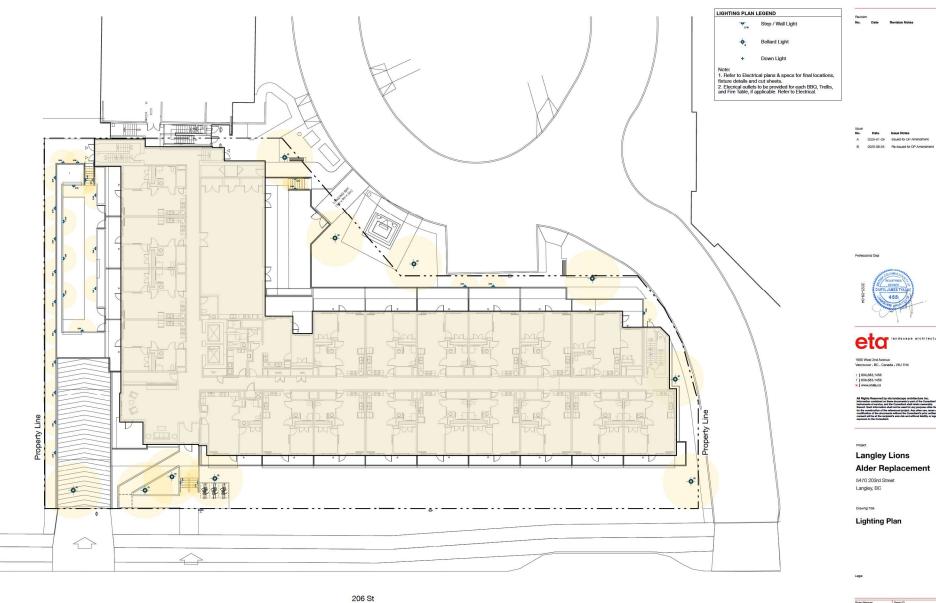
Langley Lions Alder Replacement

5470 203rd Street Langley, BC


Landscape Plan -Roof

Project Managor M/G	22517
Drawn By Drawn By	As Noted
Reviewed By	L3.1





L4.0

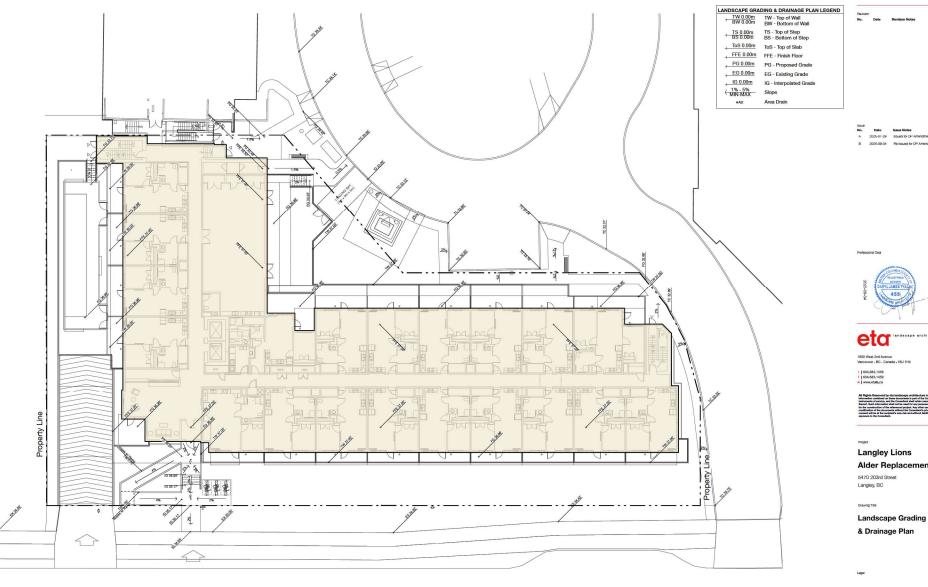

206 St






Alder Replacement

& Drainage Plan

Project Manager MG	22517
Drawn By Drawn By	As Noted
Reviewed By	L5.0

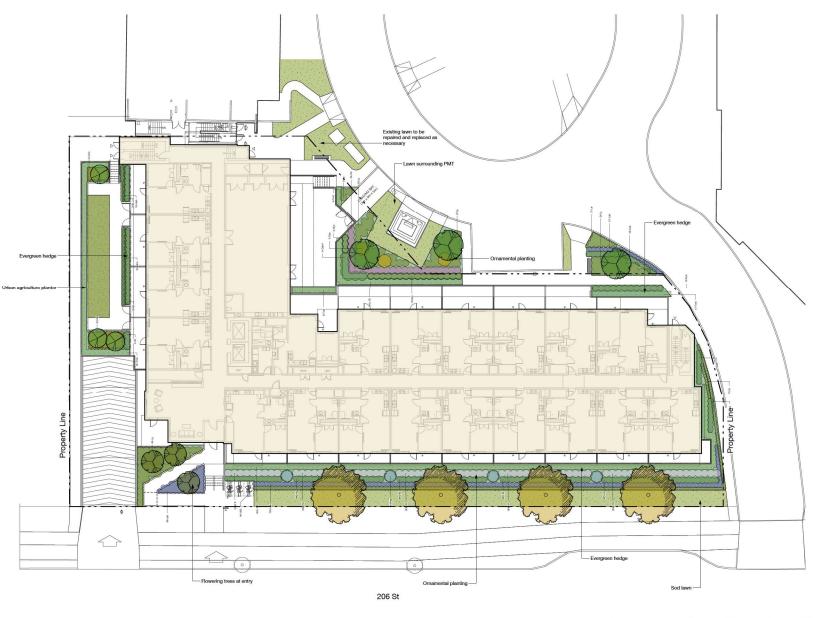

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 Date
 Issue Notes

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 2025-07-29
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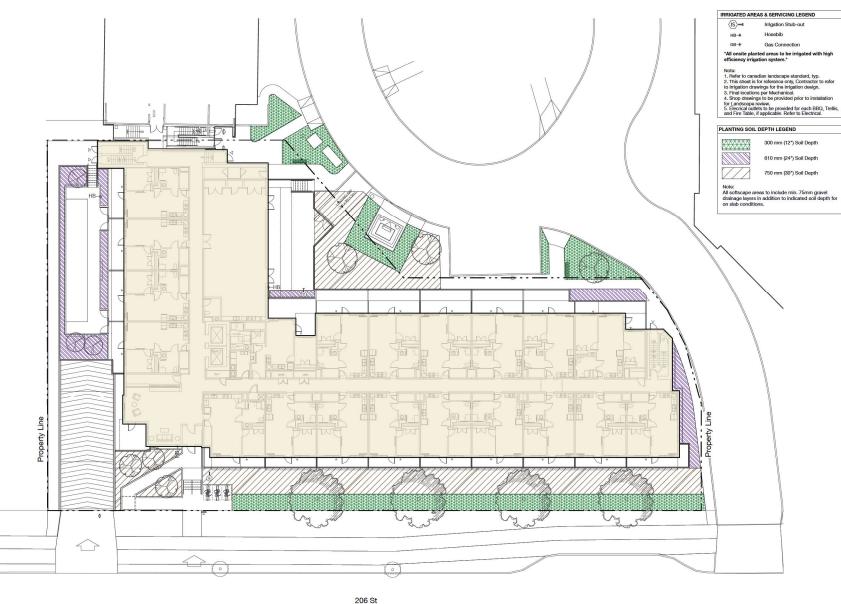
Langley Lions Alder Replacement

5470 203rd Street Langley, BC

Planting Plan

As Noted
Leaving no.
L6.0







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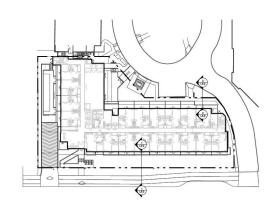
Langley Lions Alder Replacement

5470 203rd Street Langley, BC

Drawing Title

Soil Depth & Servicing Plan

Project Managor M/G	22517
Drawn By Drawn By	As Noted
Reviewed By	L7.0
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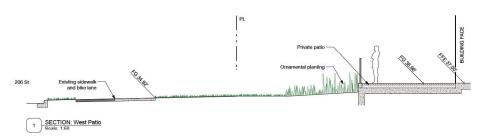
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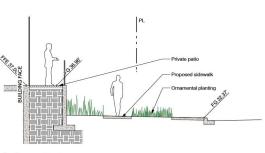
Langley Lions Alder Replacement

5470 203rd Street Langley, BC


Landscape Sections & Elevations

Project Manager MG	Project ID 22517
Drawn By Drawn By	As Noted
Reviewed By	L8.0
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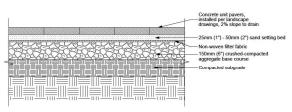


2 SECTION: East Patio Scale: 1:50




NOTE:
-Saw-cuts to be installed per layout plan, completed within 24hrs of pouring the slab
-Cantrol joints to be 1/4 slab depth
-Control joints max 8m OC, as per MMCD
-Expansion joints to be max 9m OC as per MMCD
-Concrete to be froron-finished unless otherwise noted

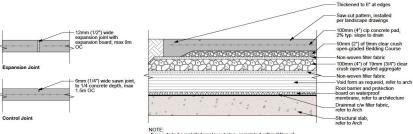
1 DETAIL: CIP Concrete on Slab Scale: 1:10



3 DETAIL: Unit Pavers on Grade Scale: 1:10

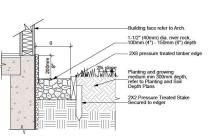


5 DETAIL: Drip Strip on Grade Scale: 1:10

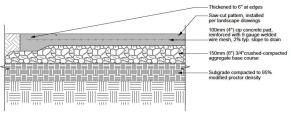


NOTE:
- Saw-cuts to be installed per layout plan, completed within 24hrs of pouring the slab pouring the slab be 1/4 slab depth
- Control joints max 3m OC, as per MMCD
- Control joints max 3m OC, as per MMCD
- Expansion joints to be max 8m OC as per MMCD
- Concrete to be broom-finished unless otherwise noted

2 DETAIL: CIP Concrete on Grade Scale: 1:10

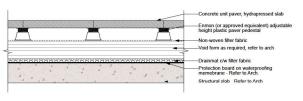

4 DETAIL: Slab Pavers on Pedestal Scale: 1:10

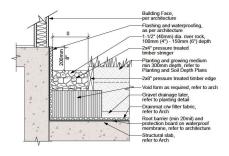

6 DETAIL: Drip Strip on Slab Scale: 1:10

No. Date Issue Notes
A 2025-07-29 Issued for DP Amendment B 2025-09-04 Re-issued for DP Amendment



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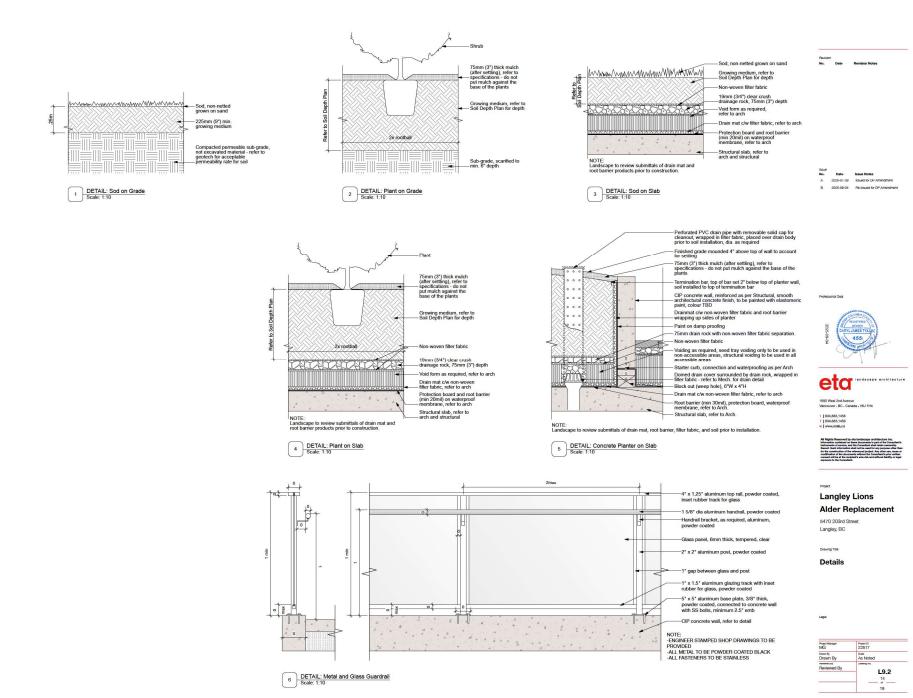
Langley Lions Alder Replacement


5470 203rd Street Langley, BC

Drawing Title


Details

Project Managor M/G	22517
Drawn By Drawn By	As Noted
Reviewed By	L9.1



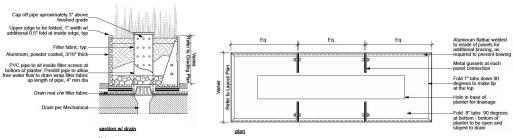


Notes:
-Shop drawings to be provided for Landscape review prior to construction.

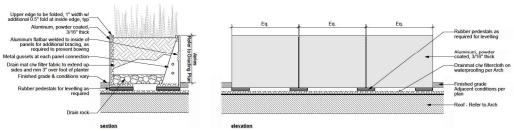

Notes:
-Shop drawings to be provided for Landscape review prior to construction.

1 DETAIL: Metal Planter Scale: 1:10

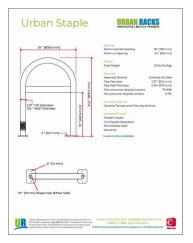







B 2005-09-04 Re-lissued for DP Amendment

Professional Seal





ct

Langley Lions Alder Replacement

5470 203rd Street Langley, BC

Drawing Title

Details

Project Manager MG	22517
Drawn By Drawn By	As Noted
Reviewed By	L9.3










1 DETAIL: Lounge Chair Scale: Actual Size

2 DETAIL: Lounge Couch Scale: Actual Size



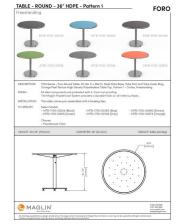

t | 604,683,1456 f | 604,683,1459 w | www.etala.ce **Langley Lions**

4 DETAIL: Chair Scale: Actual Size

5 DETAIL: Small Table Scale: Actual Size

6 DETAIL: Large Table Scale: Actual Size

Langley, BC Drawing Title Details

5470 203rd Street

Alder Replacement

eta

Project Managor M/G	22517
Drawn By Drawn By	As Noted
Reviewed By	L9.4